

REPUBLIC OF THE PHILIPPINES DEPARTMENT OF PUBLIC WORKS AND HIGHWAYS

REGION IV-B, MIMAROPA
OFFICE OF THE DISTRICT ENGINEER
BOAC, MARINDUQUE

C.Y. 2023 PROJECT

DETAILED ENGINEERING DESIGN PLAN FOR CONSTRUCTION OF SOLAR WATER SYSTEM, BUENAVISTA, MARINDUQUE

DAYKITIN, BUENAVISTA, MARINDUQUE

SUBMITTED:

RECOMMENDED:


APPROVED:

FERNAN S. DIAZ
CHIEF, PLANNING AND DESIGN SECTION

VACANT
ASSISTANT DISTRICT ENGINEER

DISTRICT ENGINEER



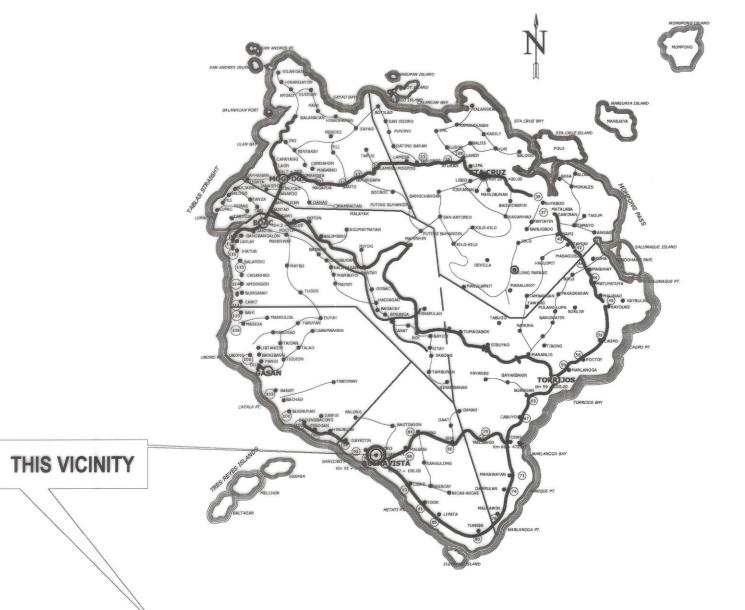



LOCATION MAP



PROJECT NAME AND LOCATION: CONSTRUCTION OF SOLAR WATER SYSTEM, BUENAVISTA, MARINDUQUE

DAYKITIN, BUENAVISTA, MARINDUQUE

SHEET CONTENTS:

KEY MAP LOCATION MAP

PREPARED:

REVIEWED:

SUBMITTED:

RECOMMENDED: VACANT
ASSISTANT DISTRICT ENGINEER

APPROVED : EVELYN R PUERTOLLANO DISTRICT ENGINEER SET NO. SHEET NO.

	INDEX OF SHEET	
CATEGORY	DESCRIPTION	SHEET NO.
	FRONT PAGE	1
	INDEX OF SHEET & SUMMARY OF QUANTITIES	0.0
	KEY MAP & LOCATION MAP	2-3
GENERAL	LOCATION PLAN	4
	TYPICAL DRAWINGS	5 - 24

ITEM NO.	DESCRIPTION	ORIGINAL QUANTITY	UNIT	REMARKS
PART A:	FACILITIES FOR THE ENGINEER			
A.1.1(8)	PROVISION OF FIELD OFFICE FOR THE ENGINEER (RENTAL BASIS)	4.00	mos.	
A.1. 2(2)	PROVISION OF 4x4 PICK UP TYPE SERVICE VEHICLE FOR THE ENGINEER ON BARE RENTAL BASIS	4.00	mos.	
PART B:	OTHER GENERAL REQUIREMENTS			
B.4 (10)	MISCELLANEOUS SURVEY AND STAKING	1.00	LS	Staked Plan To be submitted by the contractor
B.5	PROJECT BILLBOARD / SIGNBOARD	1.00	each	DPWH Standard Billboard
B.7(2)	OCCUPATIONAL SAFETY AND HEALTH PROGRAM	1.00	LS	Includes Personal Protective Equipment (PPE), Safety Signages and Health Program
B.9	MOBILIZATION / DEMOBILIZATION	1.00	LS	
PART C:	EARTHWORKS			
803(1)a	STRUCTURE EXCAVATION (COMMON SOIL)	39.27	m³	For Foundation and Pipelines
804(4)	GRAVEL FILL	3.97	m³	For Concrete Foundation
PART D:	PLAIN AND REINFORCED CONCRETE WORKS			
900(1)c2	STRUCTURAL CONCRETE FOR FOOTING AND SLAB (CLASS A, 28 DAYS)	49.29	m³	For Elevated Water Tank & Solar Control Room
902(1)a	REINFORCING STEEL (DEFORMED), GRADE 40	4,257.62	kgs	For Elevated Water Tank & Solar Control Room
902(1)b REINFORCING STEEL (DEFORMED), GRADE 60		1,518.57	kgs	For Elevated Water Tank & Solar Control Room
104(1)a	FORMWORKS AND FALSEWORKS	301.27	m ²	For Elevated Water Tank & Solar Control Room
PART E:	FINISHING WORKS			
1027(1)	CEMENT PLASTER FINISH	164.35	m ²	For Elevated Water Tank & Solar Control Room
1046(2)a1	100MM CHB NON-LOAD BEARING (INCLUDING REINFORCING STEEL)	140.52	m ²	For Elevated Water Tank & Solar Control Room
1032(1)a	PAINTING WORKS (MASONRY CONCRETE)	84.69	m ²	For Elevated Water Tank & Solar Control Room
1032(1)b	PAINTING WORKS (WOOD)	5.88	m ²	For Elevated Water Tank & Solar Control Room
1032(1)c	PAINTING WORKS (STEEL)	74.00	m ²	For Elevated Water Tank & Solar Control Room
1004(2)	FINISHING HARDWARE	1.00	LS	For Solar Control Room
1010(4)	WOODEN DOORS AND WINDOWS	1.00	LS	For Solar Control Room
1016(1)a	WATERPROOFING, CEMENT-BASE	63.16	m ²	For Elevated Water Tank & Solar Control Room
1018(1)	GLAZED TILES AND TRIMS	64.46	m ²	For Elevated Water Tank & Solar Control Room
1047(1)	STRUCTURAL STEEL	1.00	LS	For Elevated Water Tank & Solar Control Room
PART F:	PLUMBING WORKS	-		
1001(8)	SEWER LINE WORKS	1.00	LS	Solar Control Room
1001(9)	STORM DRAINAGE AND DOWNSPOUT	1.00	LS	Solar Control Room
1001(10)	PIPES WITH FITTINGS CONNECTION	1.00	LS	For Distribution Line
1002(4)	PLUMBING FIXTURES	1.00	LS	Solar Control Room
1201(1)	WATER PUMPING SYSTEM	1.00	LS	For Pipe Drilling & Solar Control Room
PART G:	ELECTRICAL WORKS			
1100(10)	CONDUIT, BOXES, AND FITTINGS (CONDUIT WORKS/CONDUIT ROUGH-IN)	1.00	LS	Solar Control Room
1101(33)	WIRES AND WIRING DEVICES	1.00	LS	Solar Control Room
1102(1)	PANEL BOARD WITH MAIN & BRANCHES BREAKERS	1.00	LS	Solar Control Room
1103(1)	LIGHTING FIXTURES AND LAMPS	1.00	LS	Solar Control Room
1102(18)	SOLAR PANEL WITH INVERTER, BATTERY AND OTHER DEVICES	1.00	LS	Solar Control Room
1103(1)	SOLAR LED STREET LIGHT	2.00	each	Solar Control Room

REPUBLIC OF THE PHILIPPINES DEPARTMENT OF PUBLIC WORKS AND HIGHWAYS REGION IV - B , MIMAROPA OFFICE OF THE DISTRICT ENGINEER
BOAC, MARINDUQUE


CONSTRUCTION OF SOLAR WATER SYSTEM,
BUENAVISTA, MARINDUQUE

DAYKITIN, BUENAVISTA, MARINDUQUE

PROJECT NAME AND LOCATION:

SHEET CONTENTS :

INDEX OF SHEETS
SUMMARY OF QUANTITIES

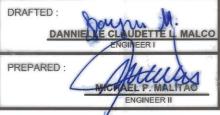





VACANT


ASSISTANT DISTRICT ENGINEER

DATE:

RECOMMENDED:

EVELYN R INJERT OLLANO
DISTRICT ENGINEER
DATE:



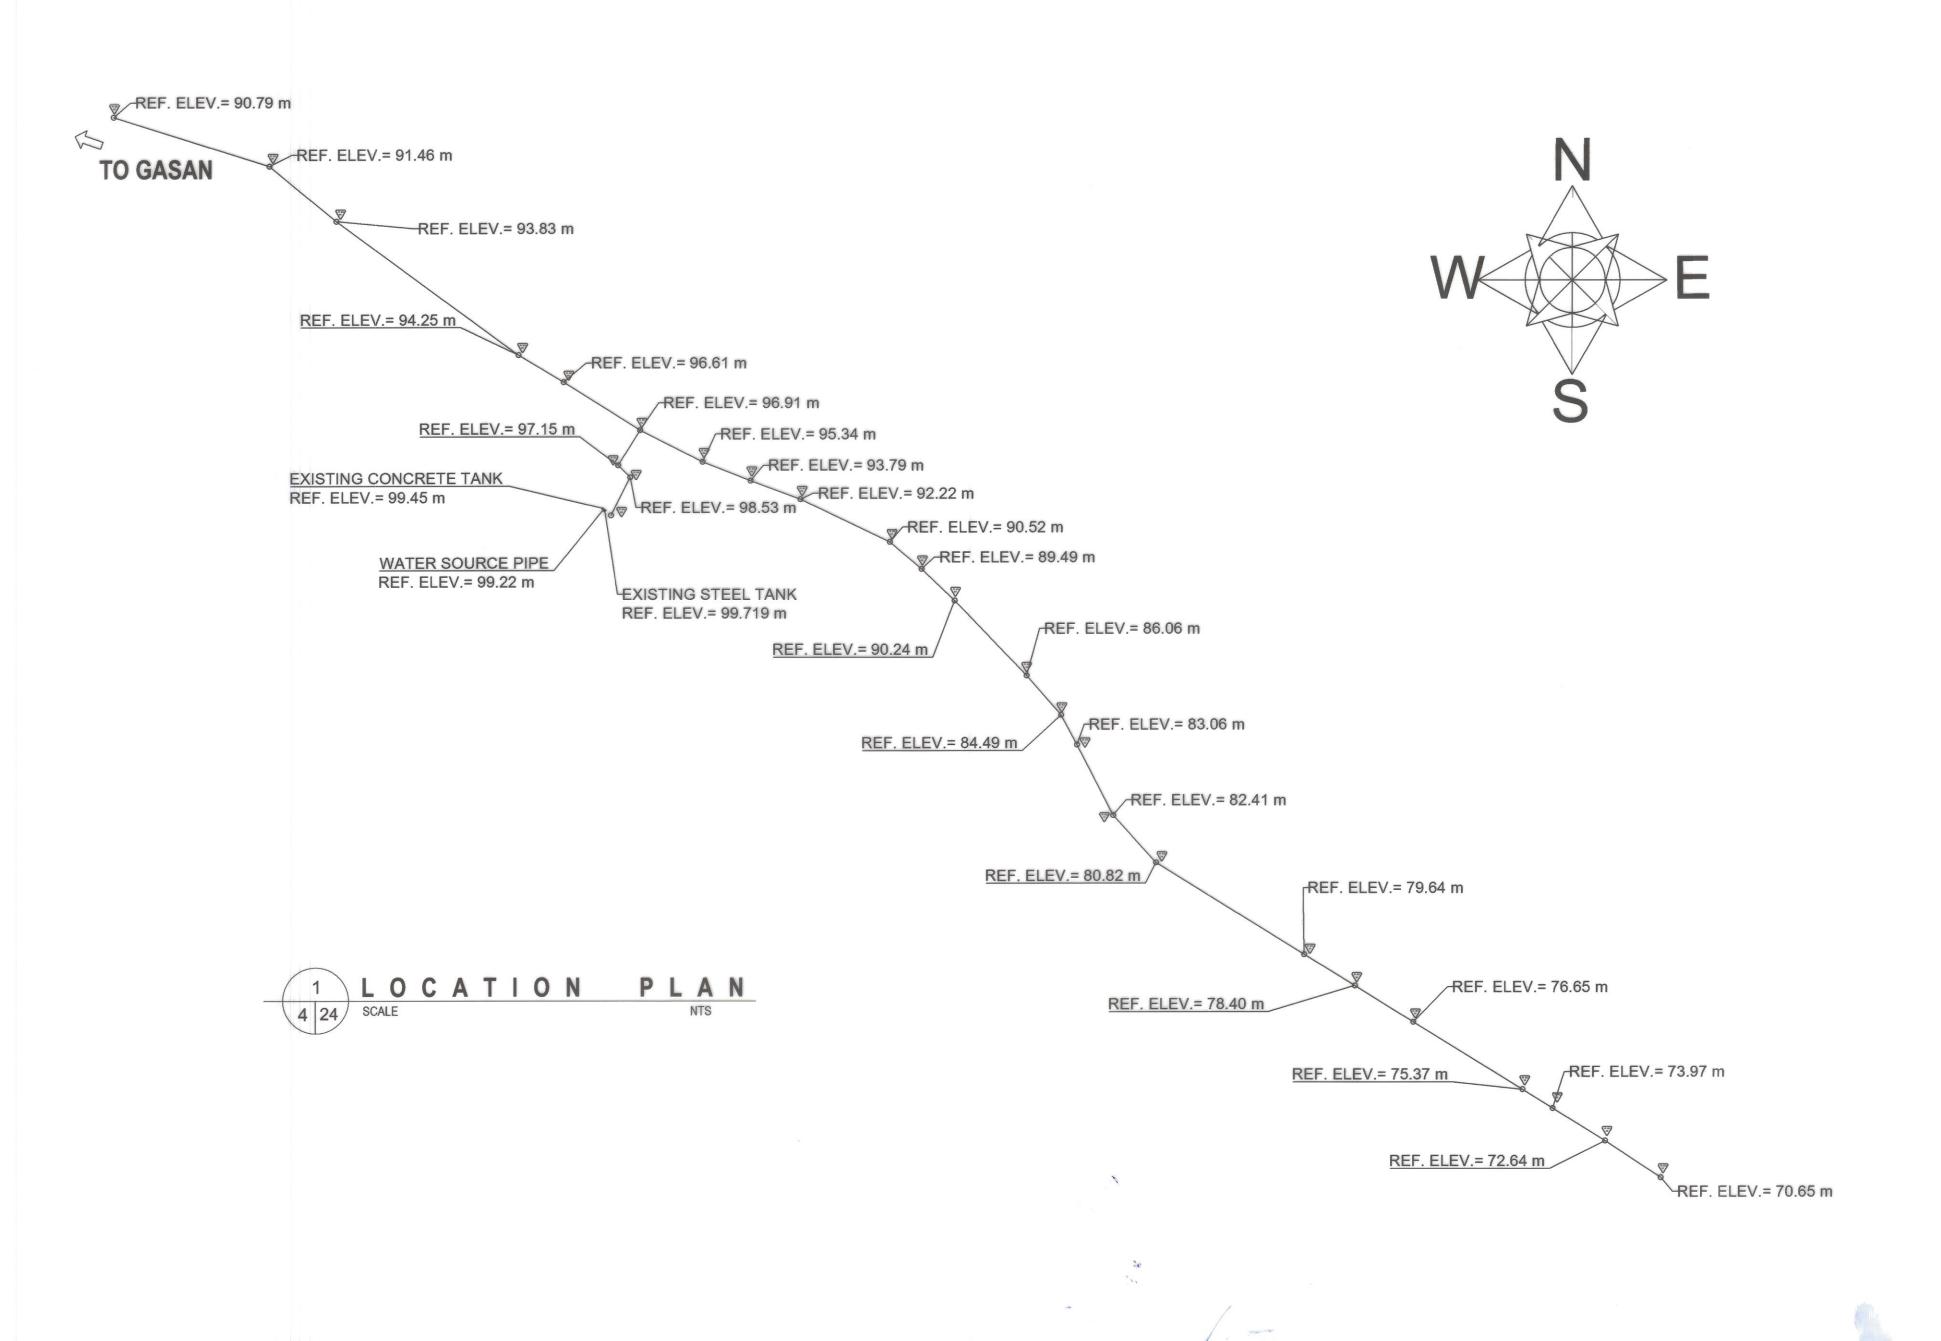

REPUBLIC OF THE PHILIPPINES
DEPARTMENT OF PUBLIC WORKS AND HIGHWAYS
REGION IV - B , MIMAROPA
OFFICE OF THE DISTRICT ENGINEER
BOAC , MARINDUQUE


PROJECT NAME AND LOCATION :

CONSTRUCTION OF SOLAR WATER SYSTEM,
BUENAVISTA, MARINDUQUE

DAYKITIN, BUENAVISTA, MARINDUQUE

TYPICAL ROADWAY SECTION

SHEET CONTENTS:

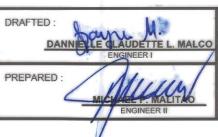

JERSON O. MONTERA
ENGINEER II

FERNAN S. DIAZ

CHIEF, PLANNING AND DESIGN SECTION
DATE:

VACANT
ASSISTANT DISTRICT ENGINEER
DATE:

RECOMMENDED:


EVELYN R/PUERTOLLANO
DISTRICT ENGINEER
DATE:

APPROVED:


DPWH REGION IV-B CY - 2023

SET NO. SHEET NO.

TYPICAL ROADWAY SECTION

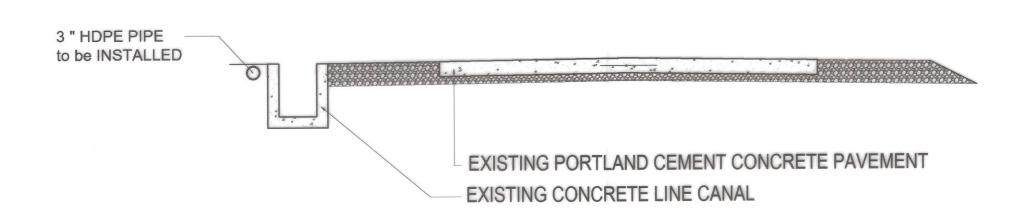

SECTION THRU FARM TO MARKET ROAD

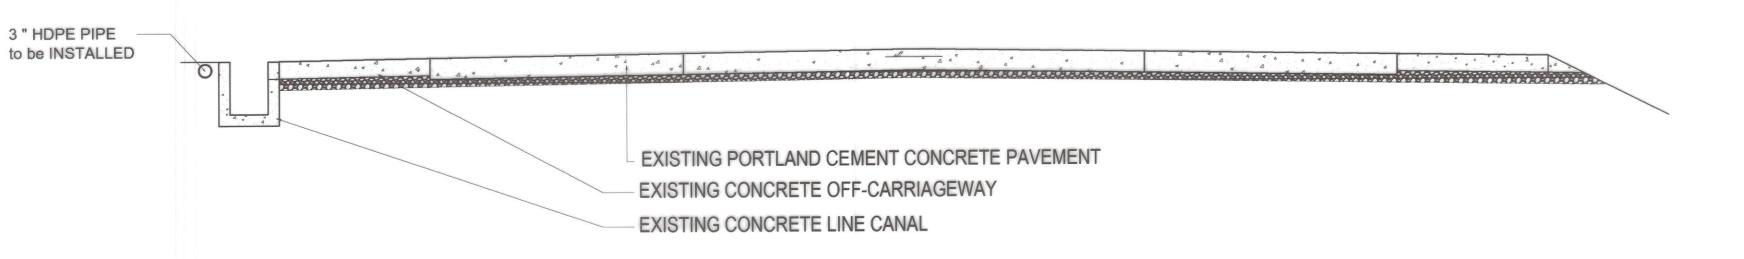

SECTION THRU NATIONAL ROAD

REGION IV - B , MIMAROPA		OFFICE OF THE DISTRICT ENGINEER
--------------------------	--	---------------------------------

	PROJECT NAME AND LOCATION:
ND HIGHWAYS A ENGINEER	CONSTRUCTION OF SOLAR WATER SYSTEM, BUENAVISTA, MARINDUQUE

JECT NAME AND LOCATION :

DAYKITIN, BUENAVISTA, MARINDUQUE

TYPICAL ROADWAY SECTION

SHEET CONTENTS:

PREPARED


REVIEWED:


SUBMITTED:


RECOMMENDED:


APPROVED:




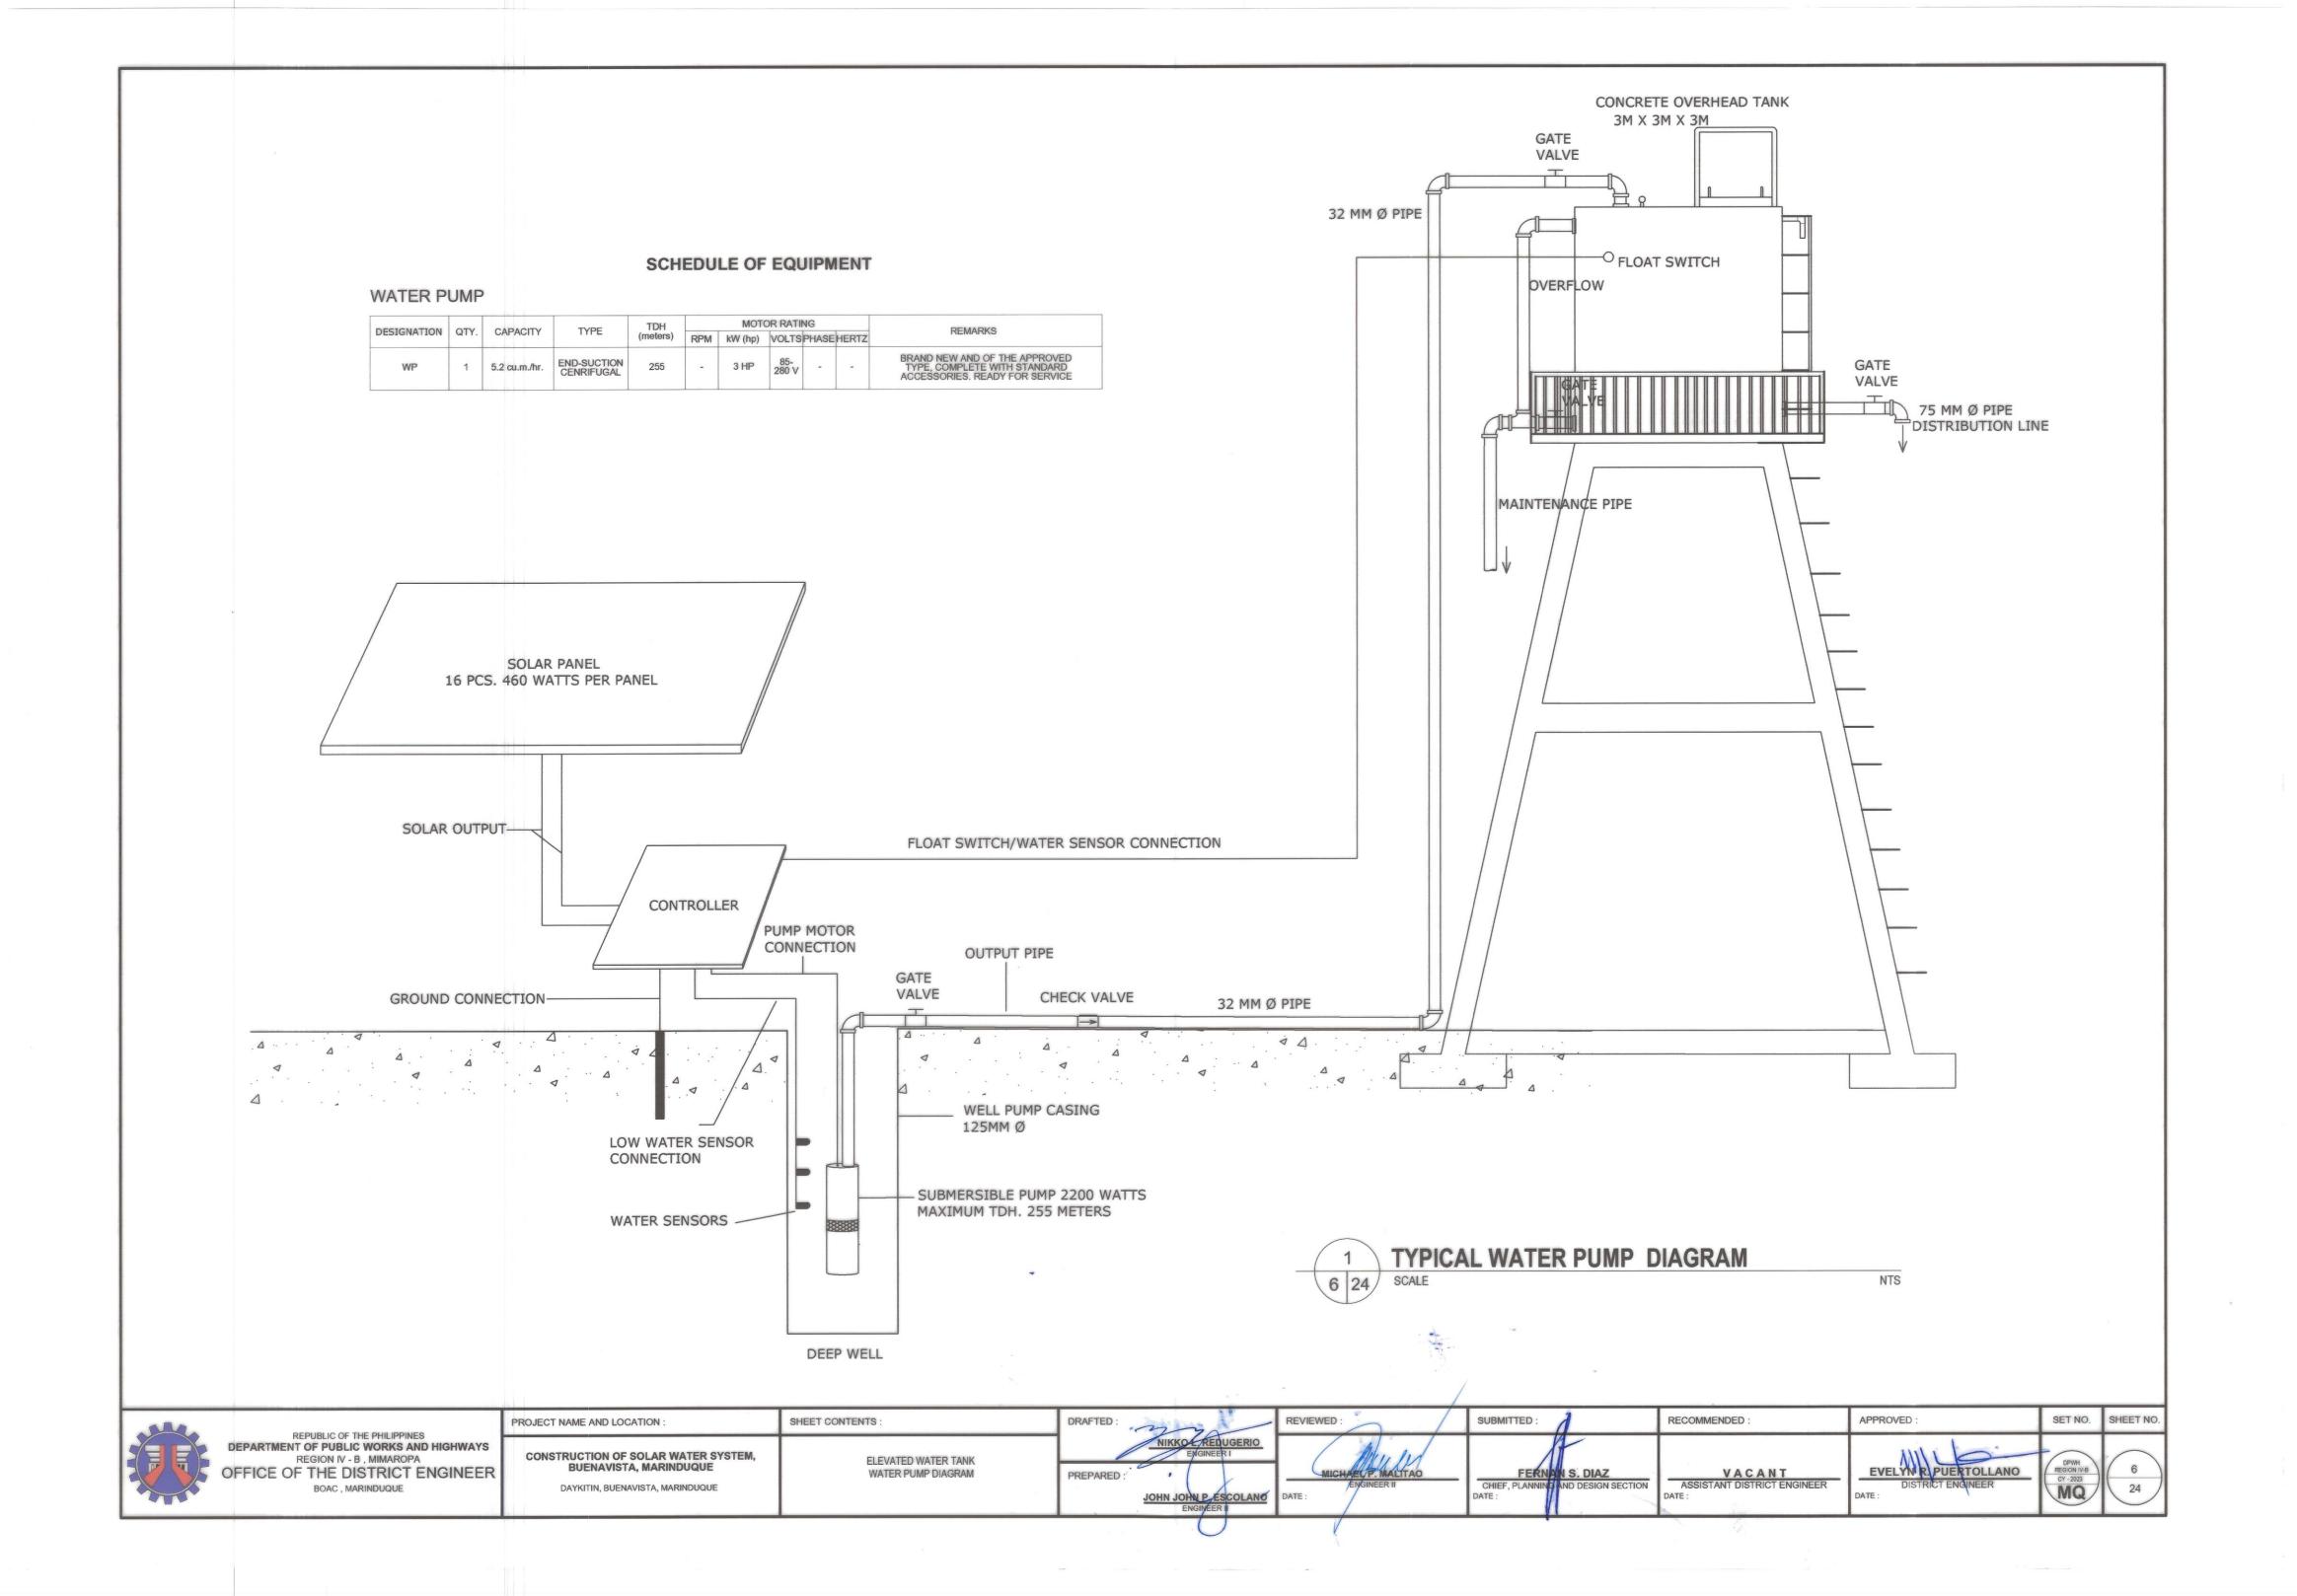


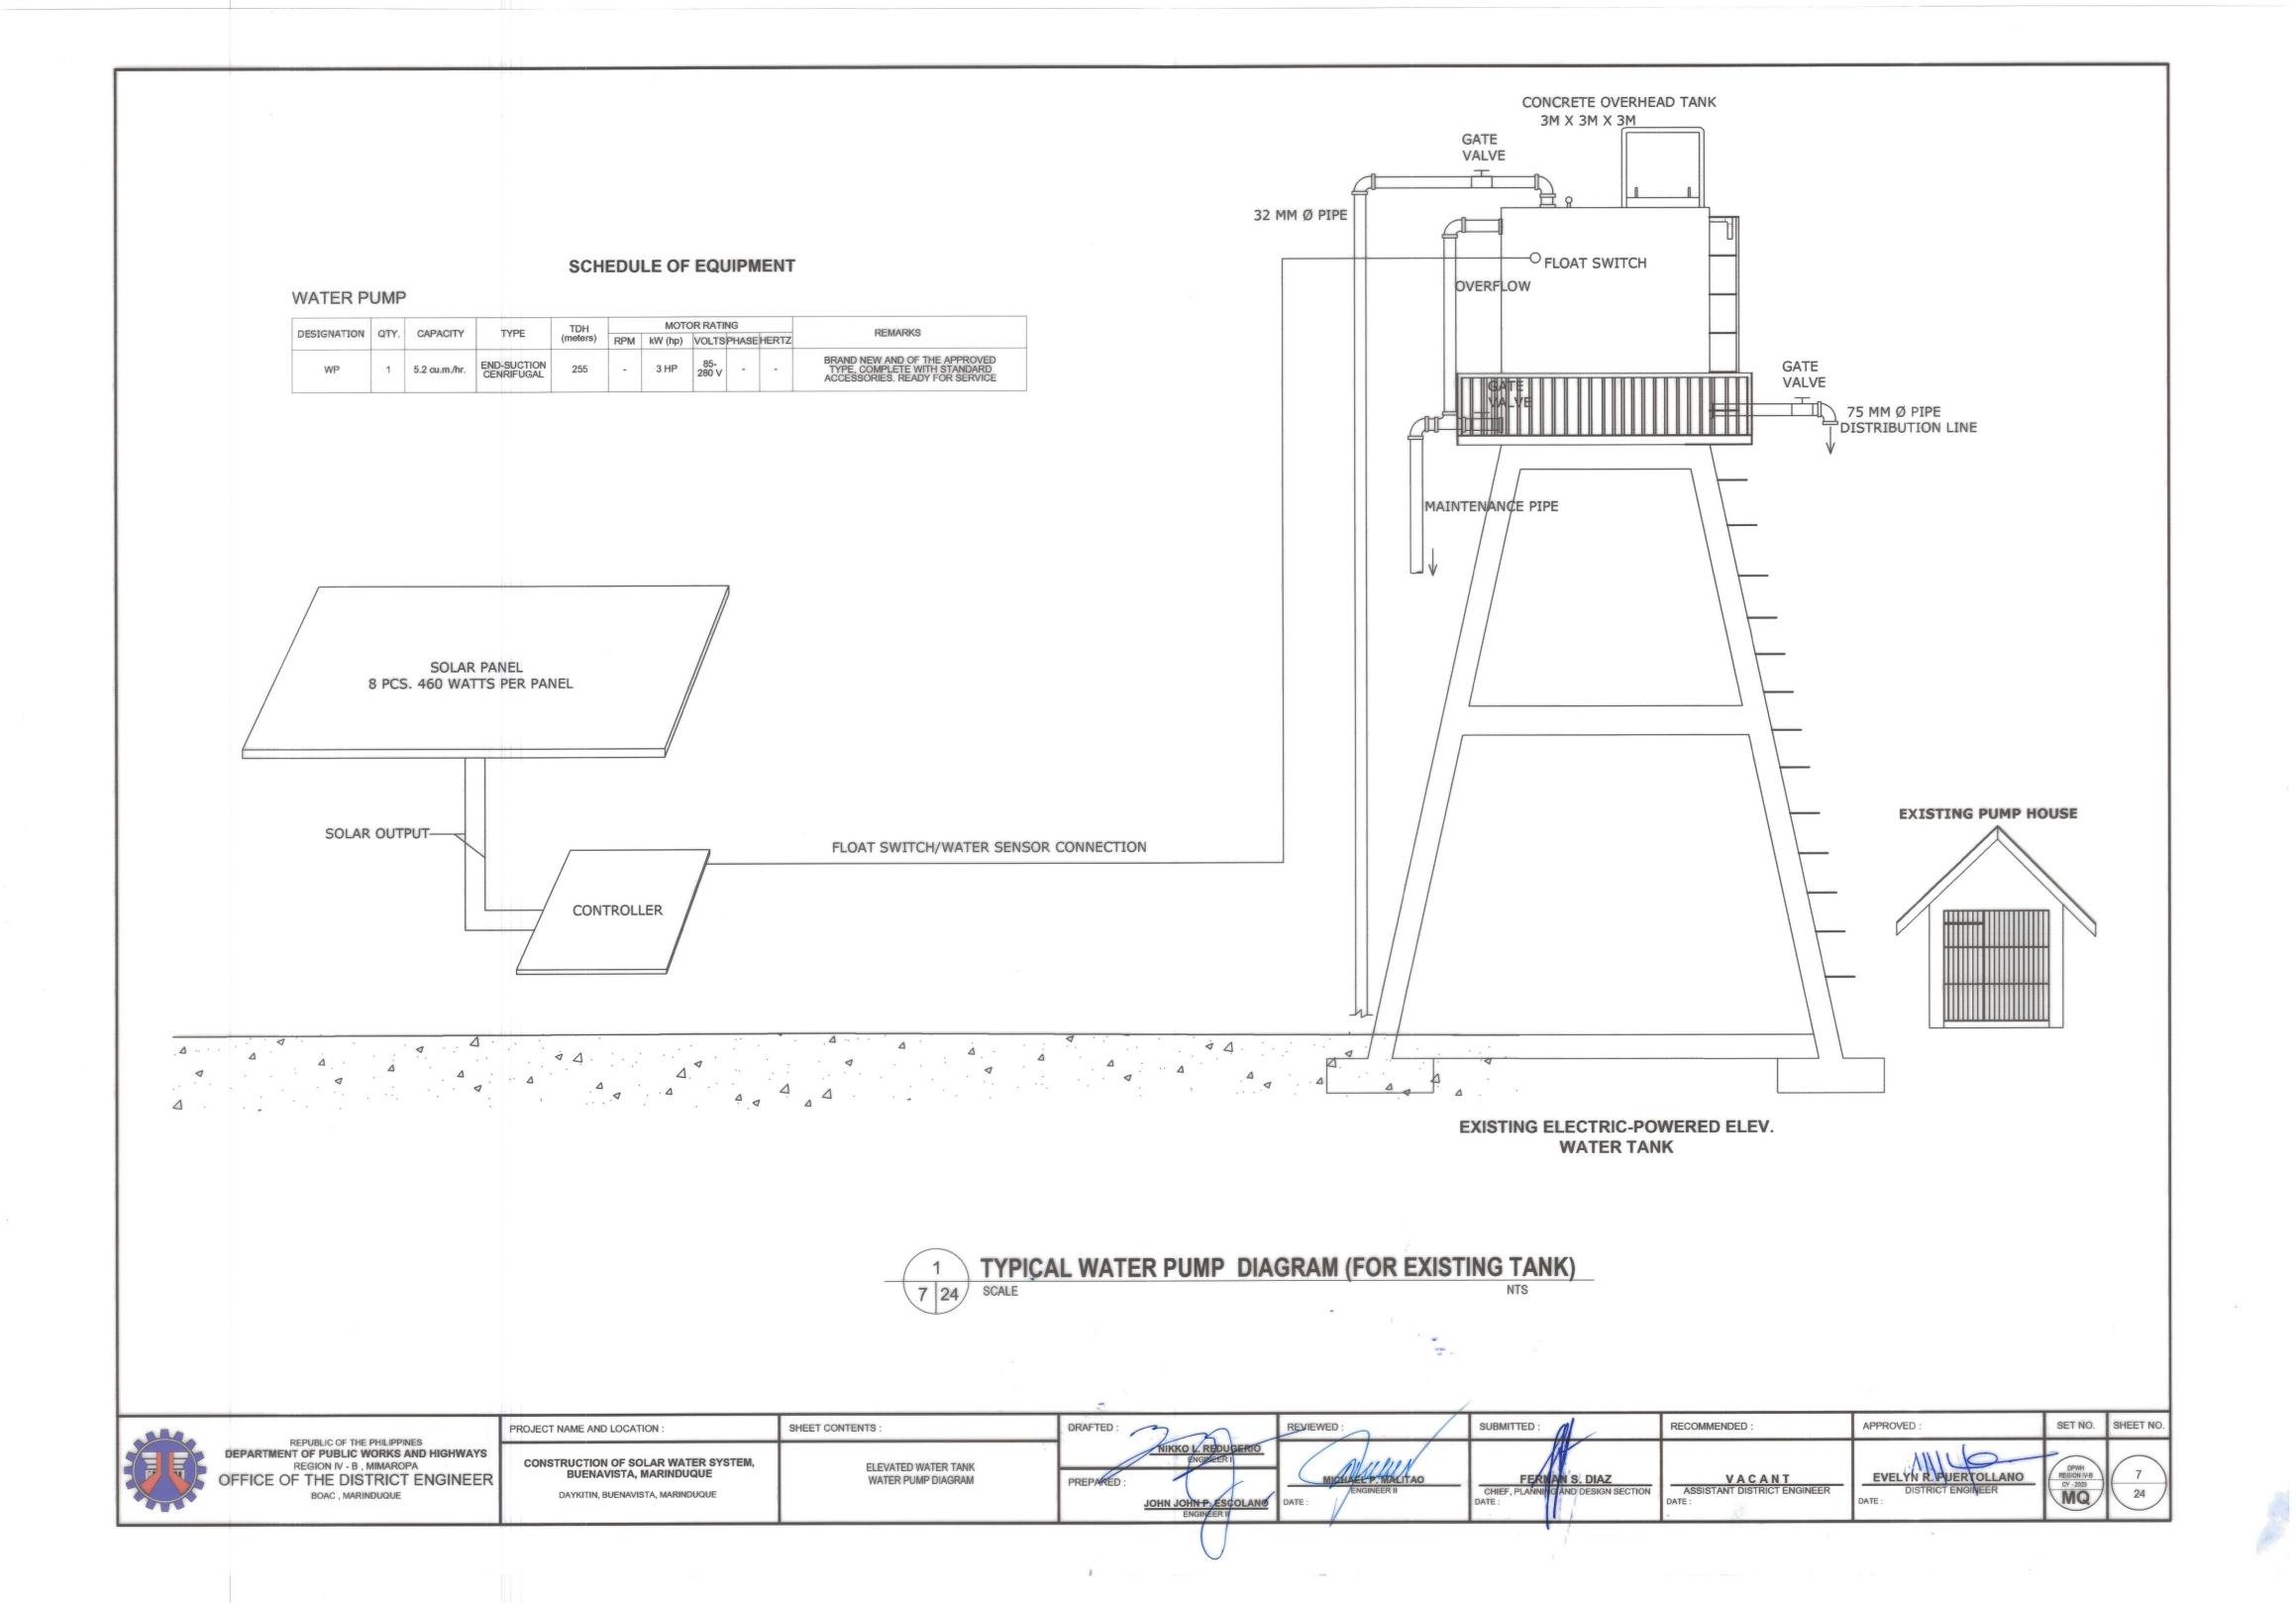


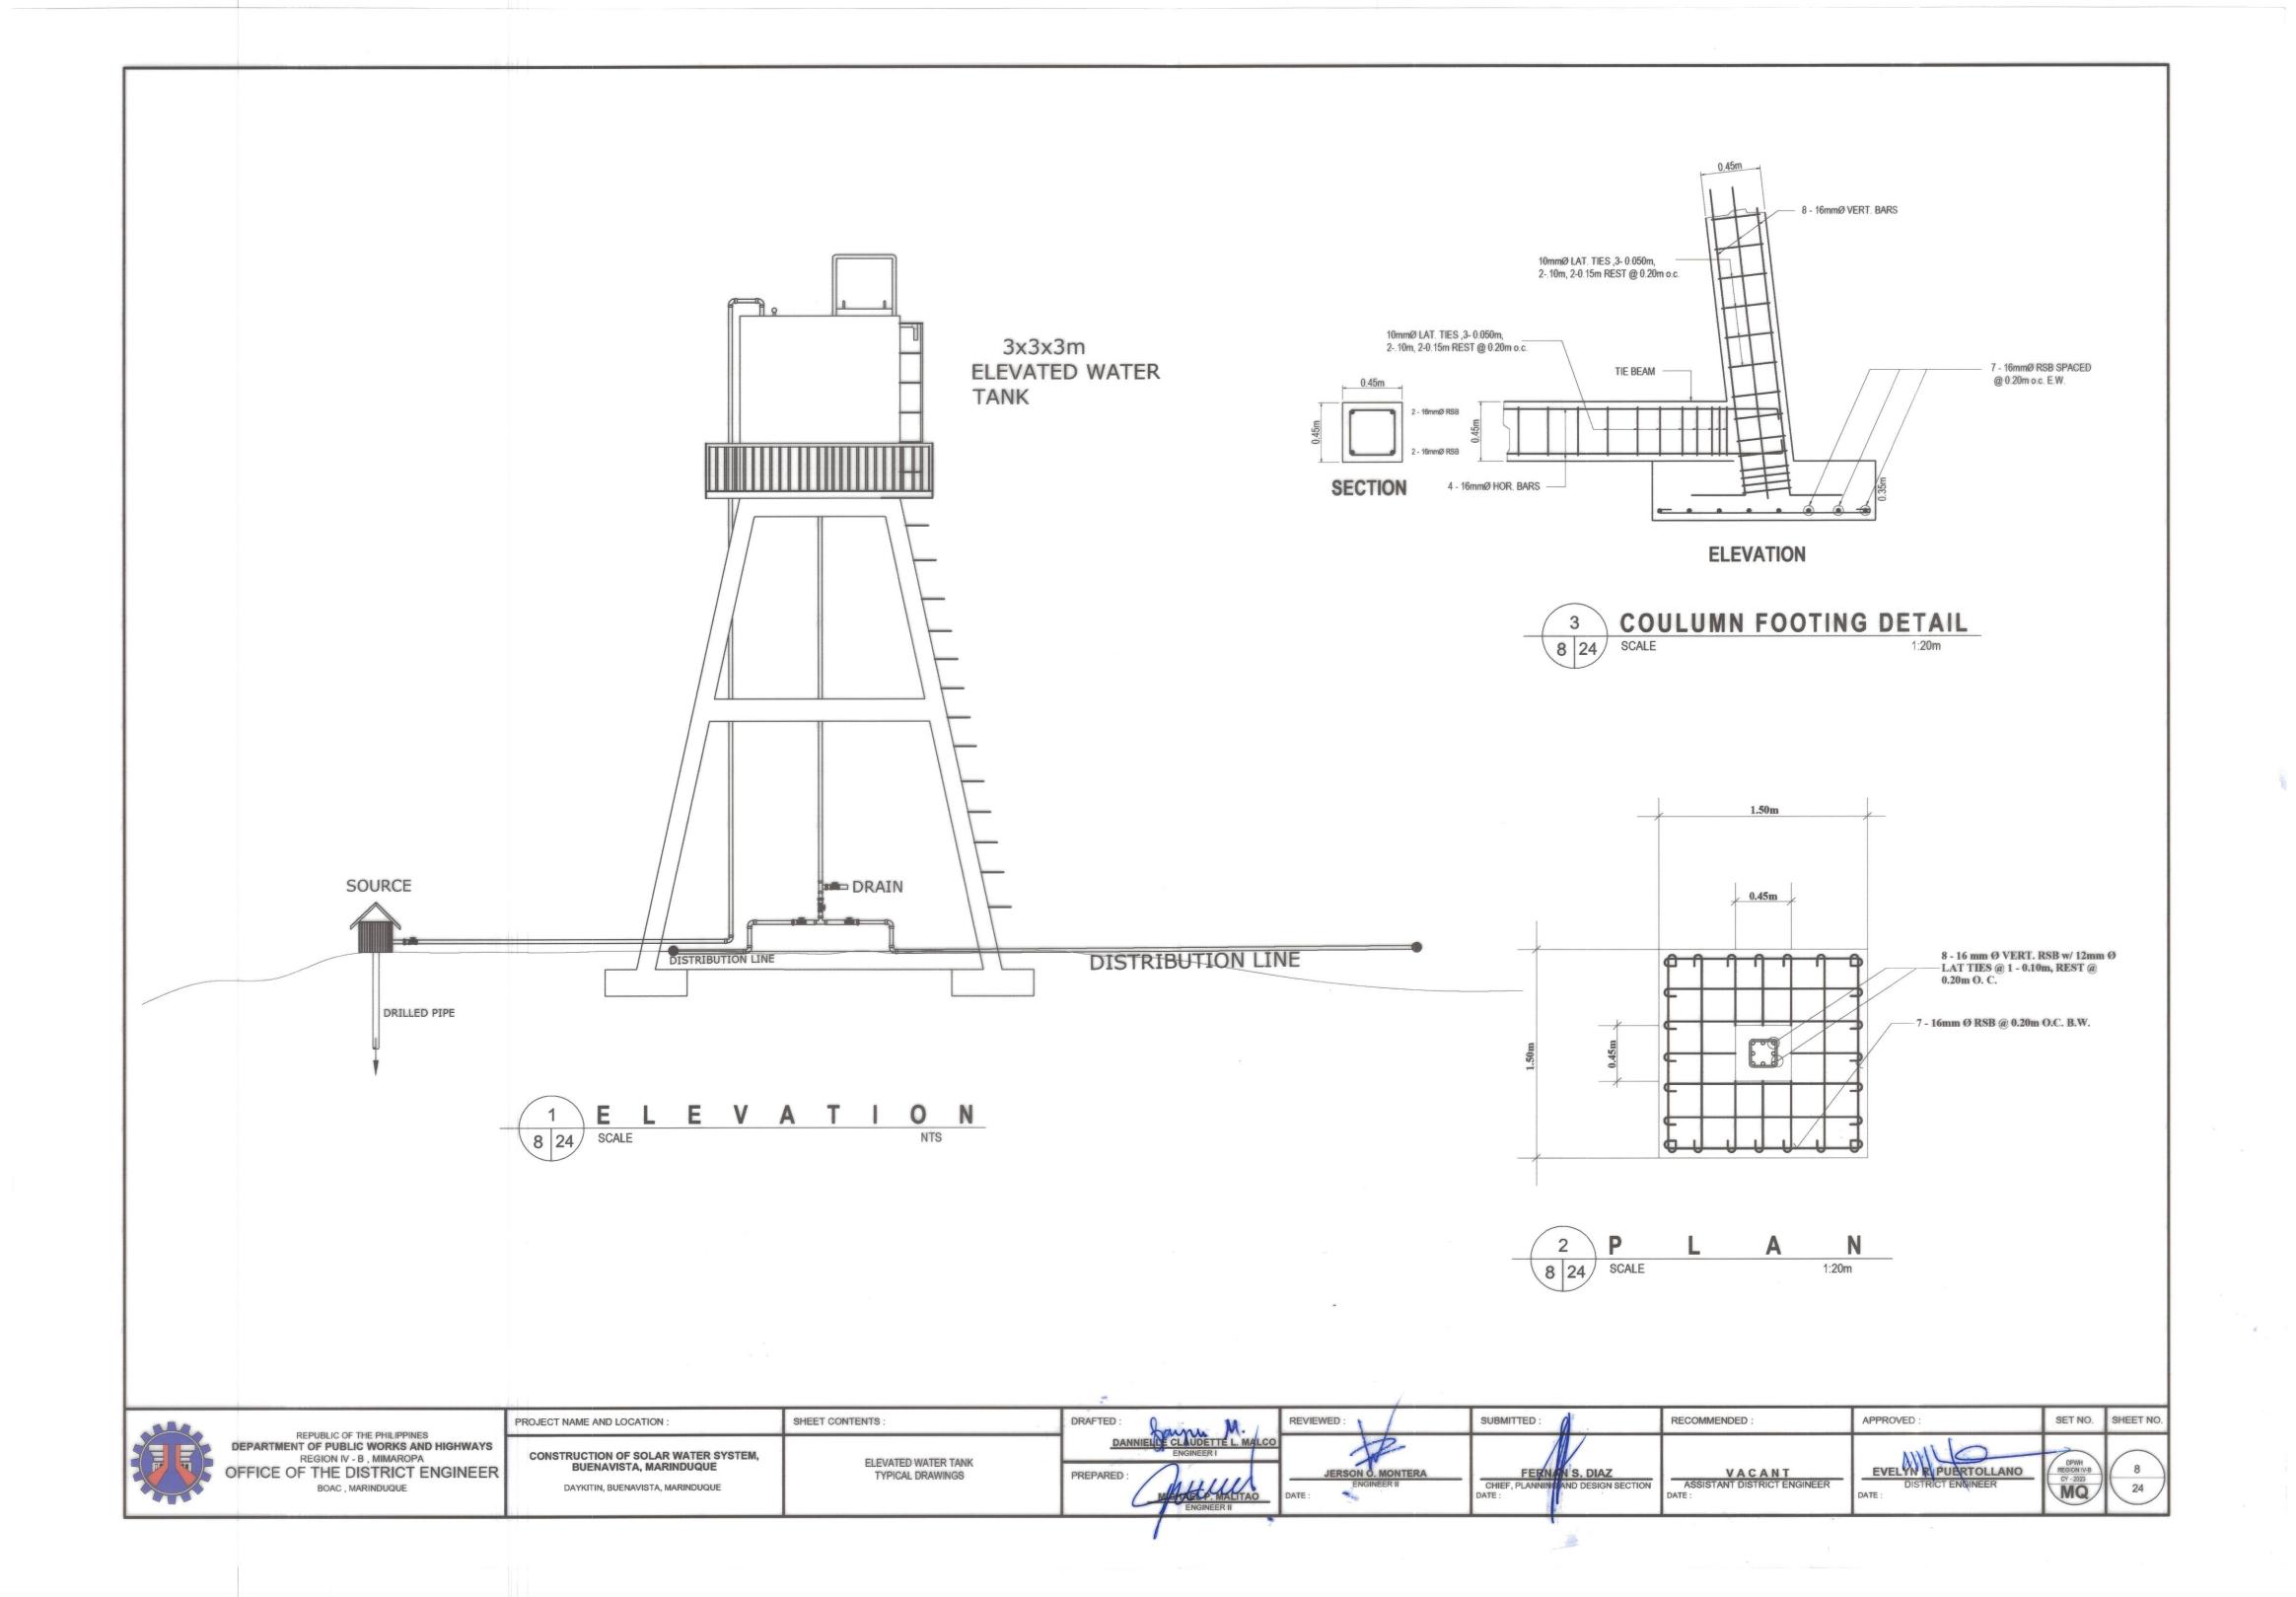

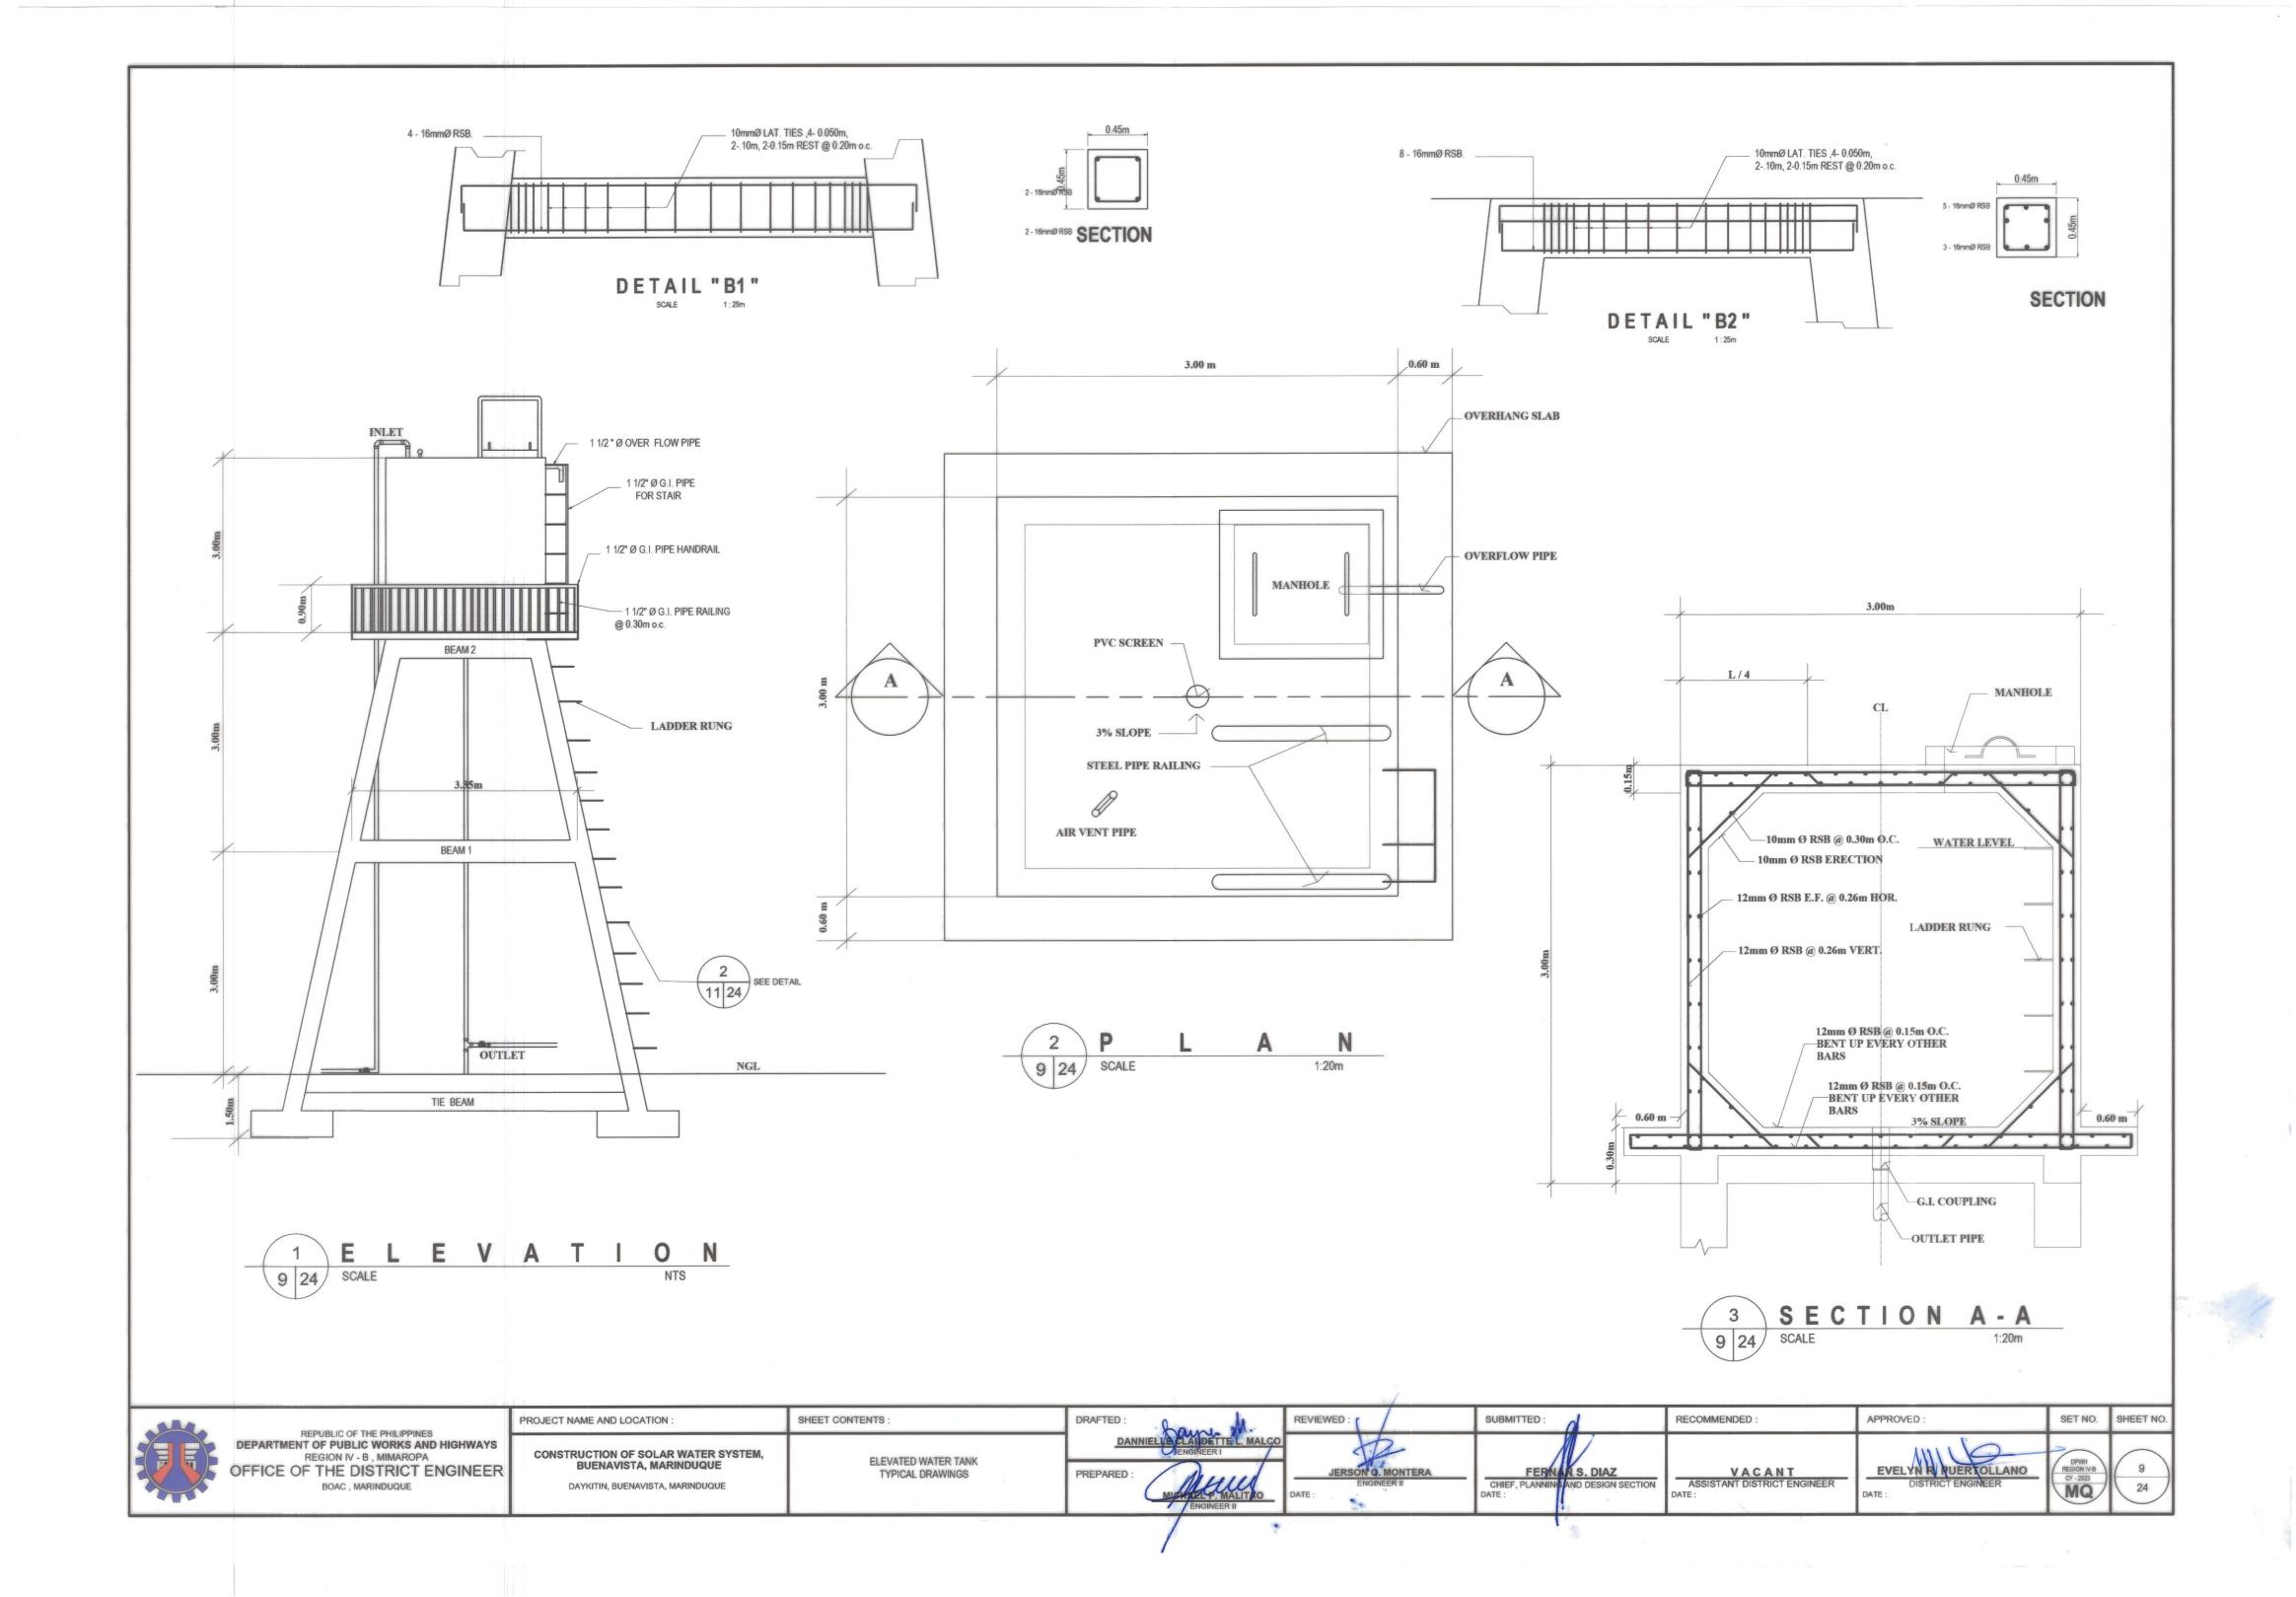

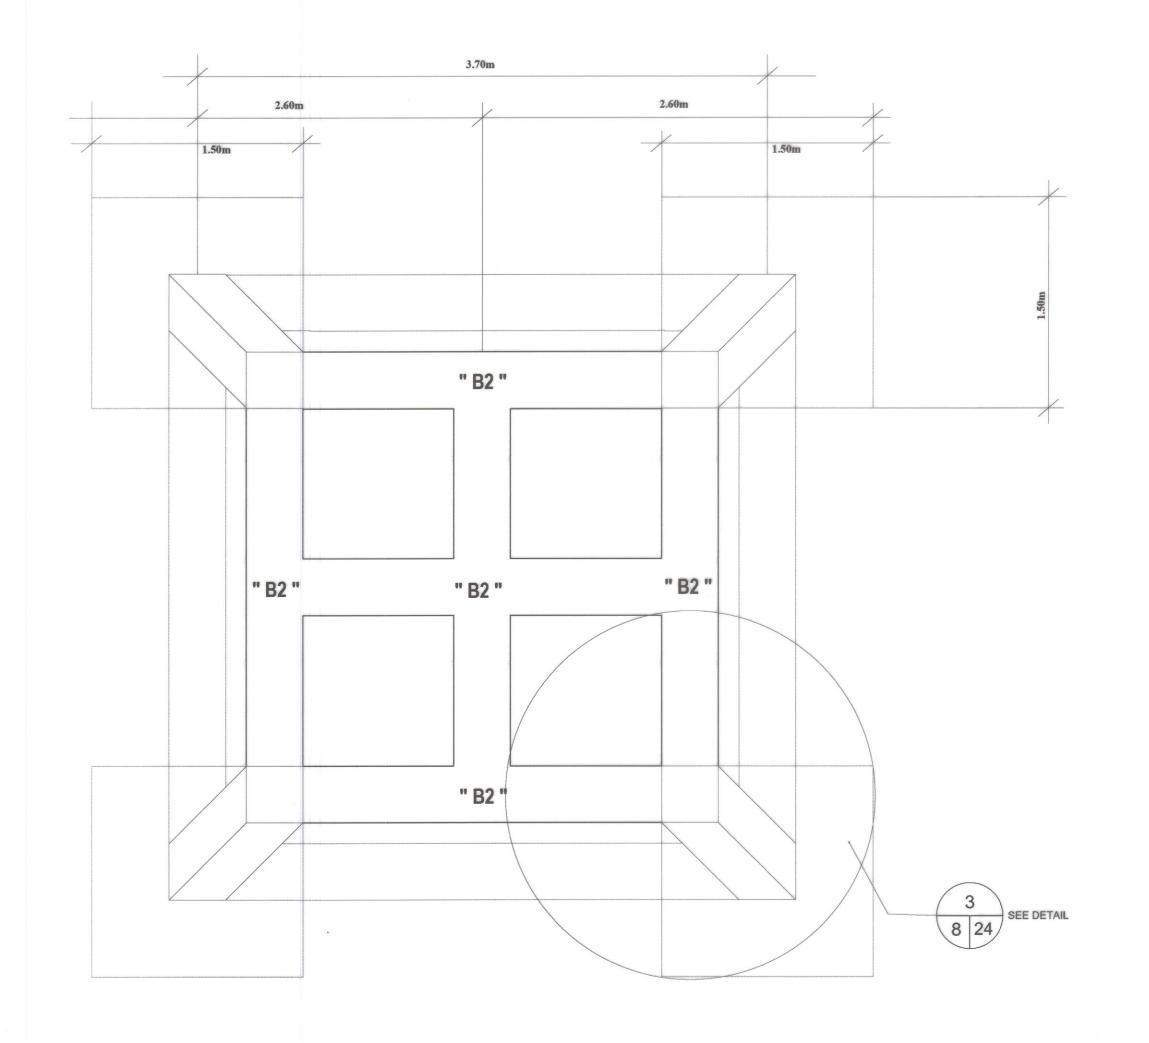

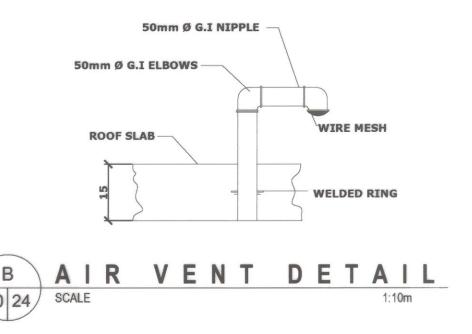

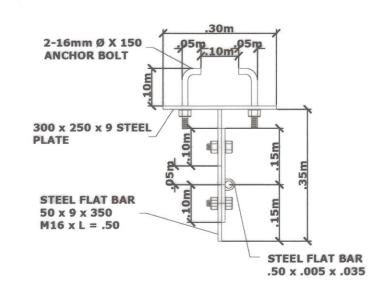

C DETAIL OF PIPE HOLDER
10 24 SCALE 1:10m




SHEET CONTENTS:

ELEVATED WATER TANK TYPICAL DRAWINGS

REPUBLIC OF THE PHILIPPINES DEPARTMENT OF PUBLIC WORKS AND REGION IV - B , MIMAROPA OFFICE OF THE DISTRICT EI BOAC , MARINDUQUE	1
---	---

	PROJECT NAME AND LOCATION:
	CONSTRUCTION OF SOLAR WATER SYSTEM, BUENAVISTA, MARINDUQUE
	DAYKITIN, BUENAVISTA, MARINDUQUE
- 1	

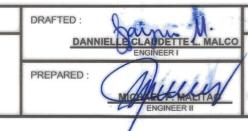


- 4	REVIEWED:
ETTE L. MALCO	JERSO
NEER II	DATE:

VIEWED:	SUBMITTED:
JERSON O. MONTERA ENGINEER II	FERNAL S. DIAZ CHIEF, PLANNING AND DESIGN S DATE:


	RECOMMENDED:
N SECTION	VACANT ASSISTANT DISTRICT ENGINEER DATE:

APPROVED :	L
EVELYN R. PUERTOLLANO DISTRICT ENGINEER DATE:	-




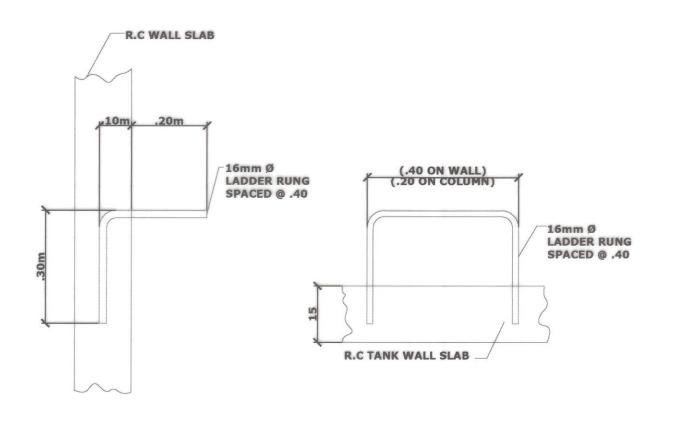


DETAIL OF LADDER RUNG 11 24 SCALE

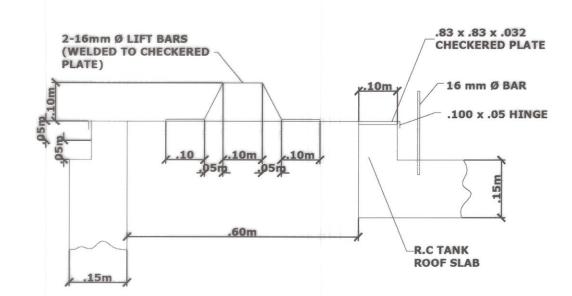


DETAIL OF MANHOLE

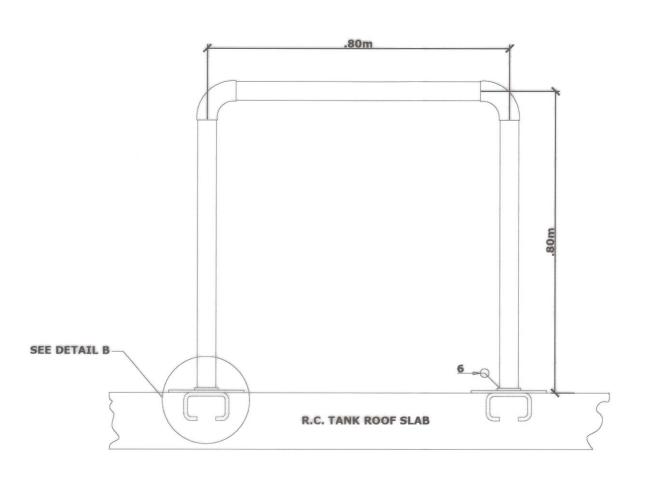

DETAIL OF STEEL PIPE RAILING
SCALE 1:10m

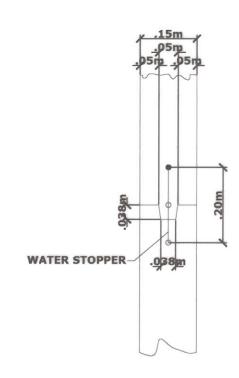

CONST. JOINT DETAIL

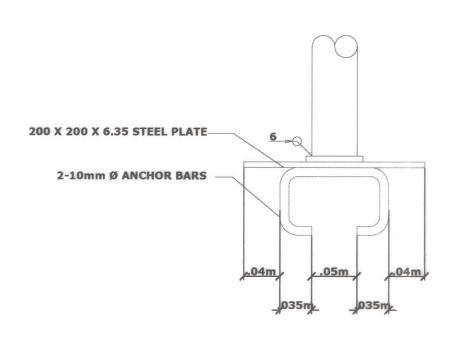

В

REPUBLIC OF THE PHILIPPINES DEPARTMENT OF PUBLIC WORKS AND HIGHWAYS REGION IV - B , MIMAROPA OFFICE OF THE DISTRICT ENGINEER BOAC MARINDUOUE
BOAC, MARINDUQUE

IGHWAYS	CONST
GINEER	

PROJECT NAME AND LOCATION: TRUCTION OF SOLAR WATER SYSTEM, BUENAVISTA, MARINDUQUE DAYKITIN, BUENAVISTA, MARINDUQUE

SHEET CONTENTS:


ELEVATED WATER TANK TYPICAL DRAWINGS

DRAFTED : DANNIEU E CLA	UDETTE L. MALCO
PREPARED :	MALITAGE DE LA CONTROL DE LA C


					_
. 3	REVIE	WED:	1		
MALCO			4	P	-
		JERS	ON O.	MONT	TER
1//			ENGIN	EER II	
AO	DATE :				


SUBMITTED:	
4	M
CHIEF, PLANNING	S. DIAZ
DATE:	La . La s


L	RECOMMENDED:
T	
l	
k	VACANT
ŀ	ASSISTANT DISTRICT ENGINEER
п.	DATE:
11	ALL.

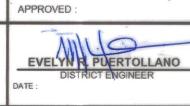




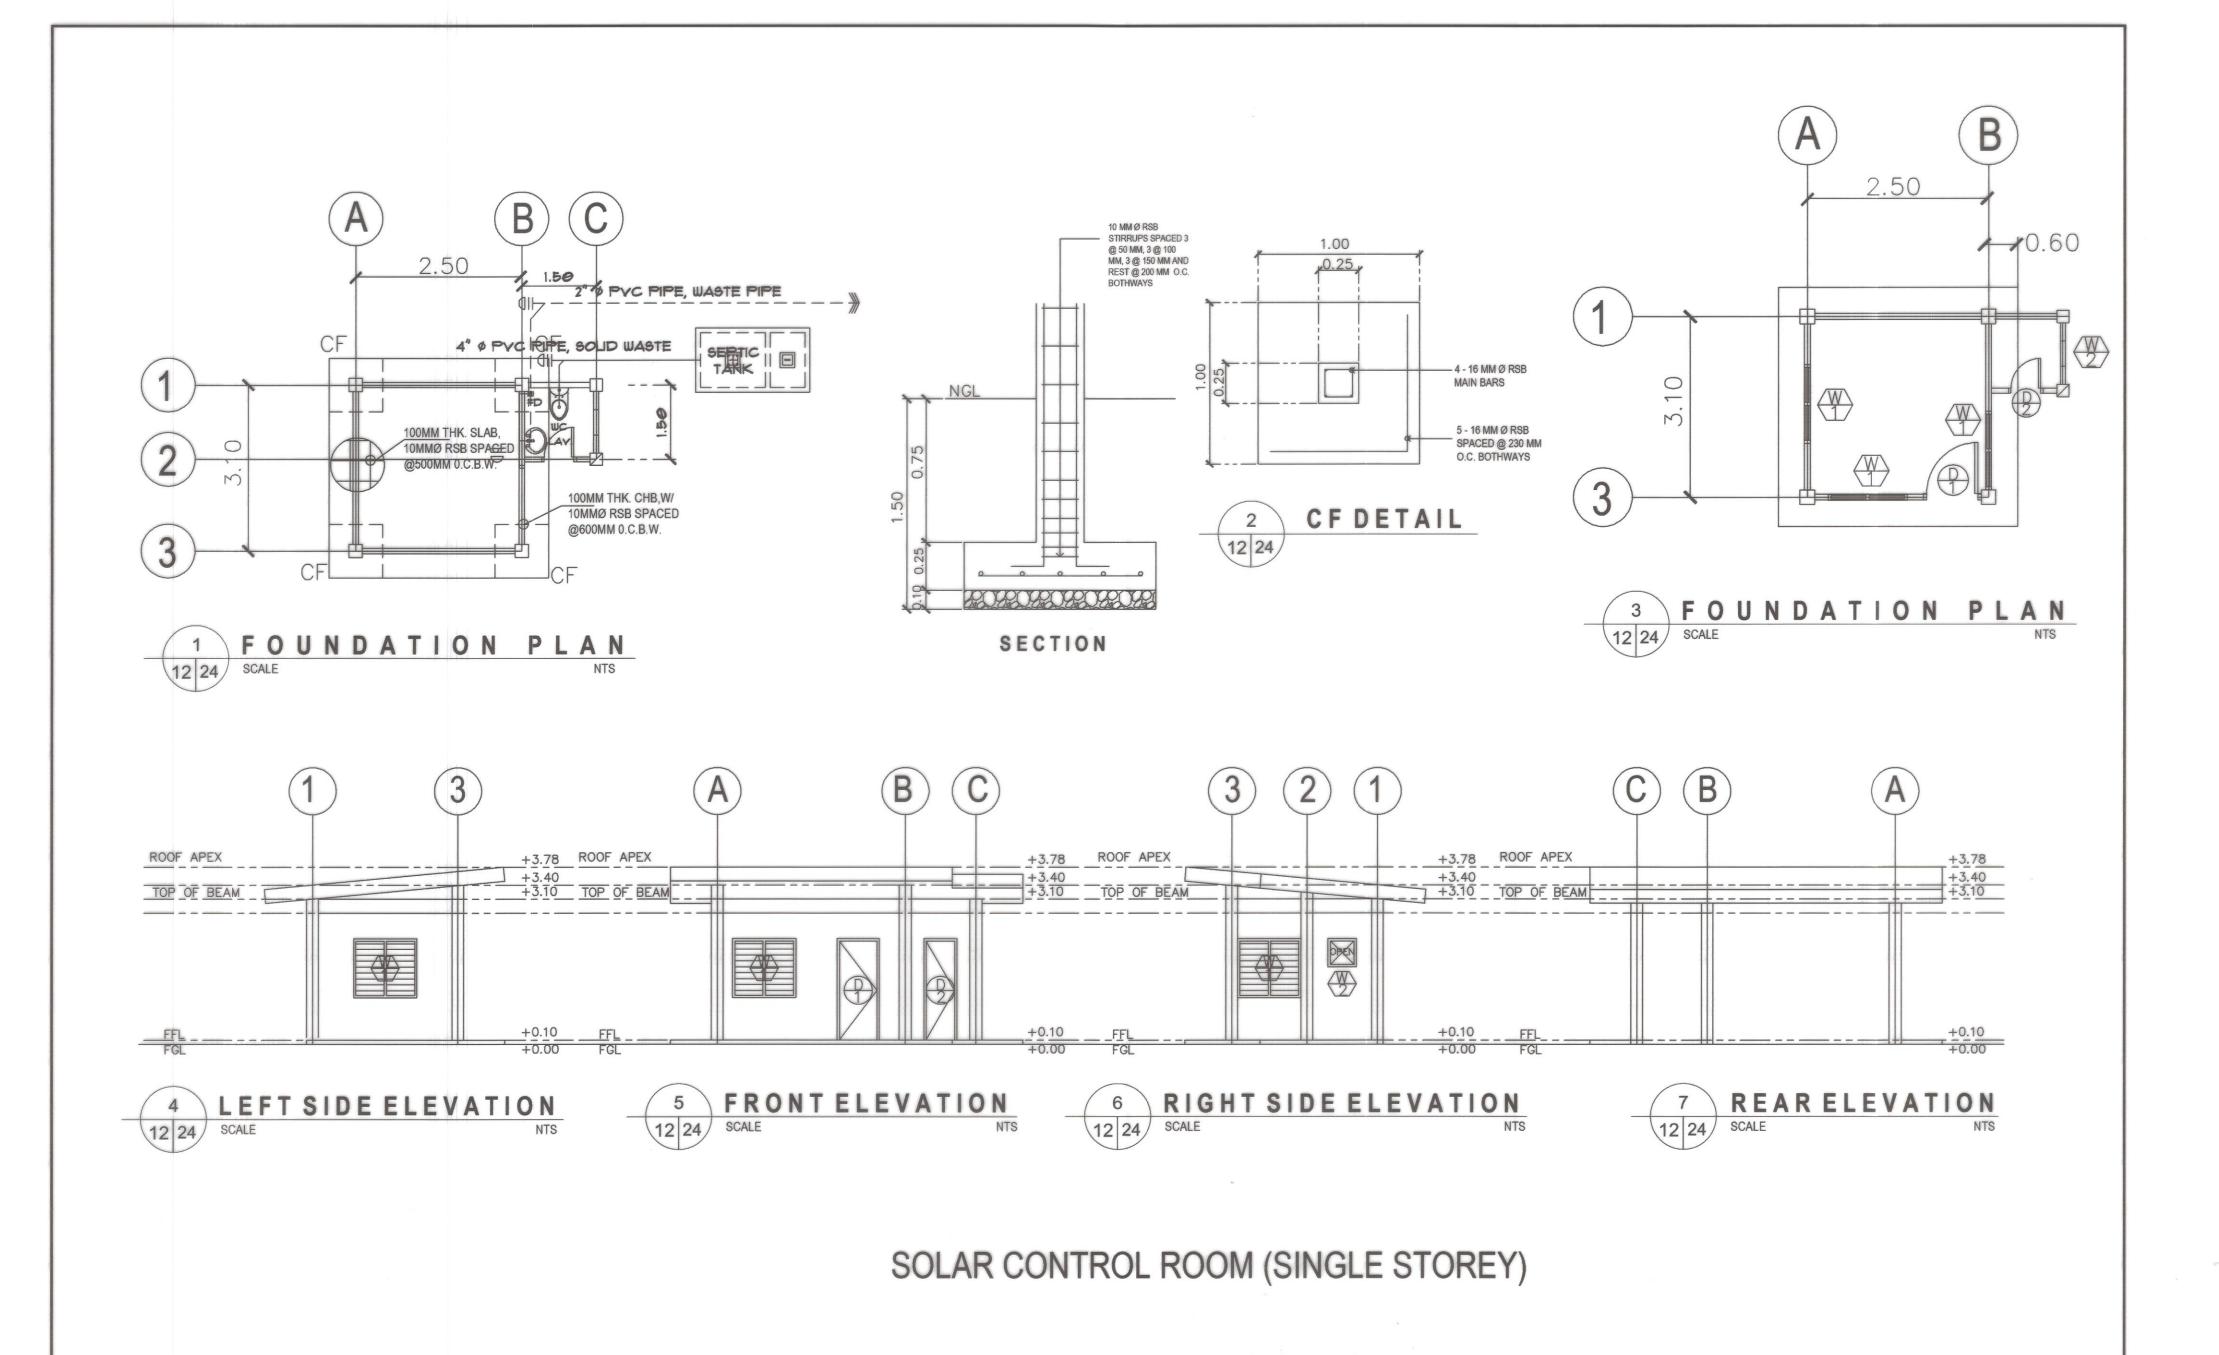

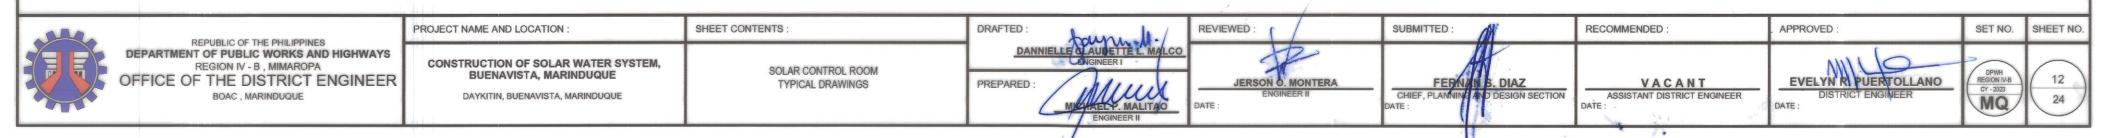


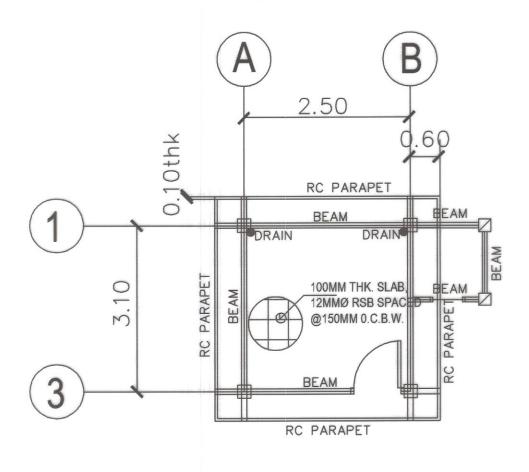


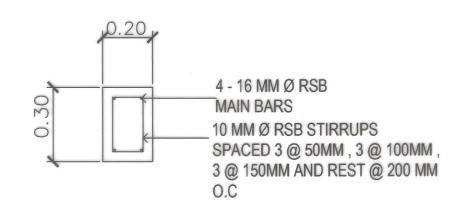






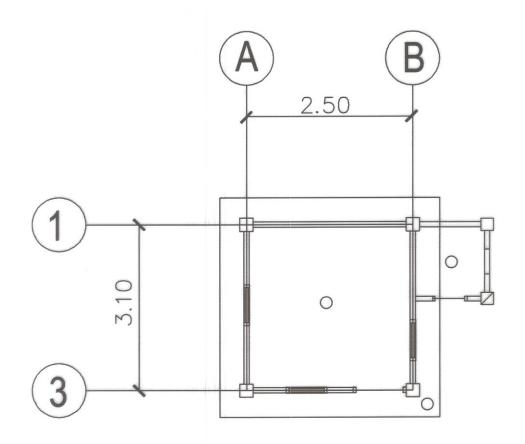


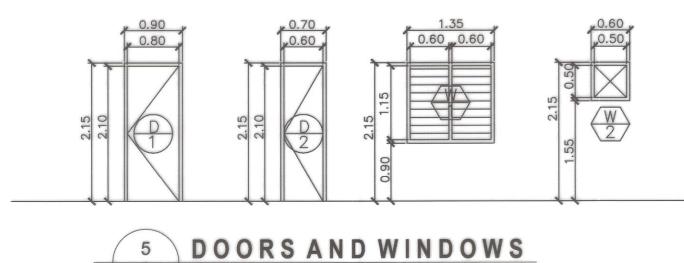






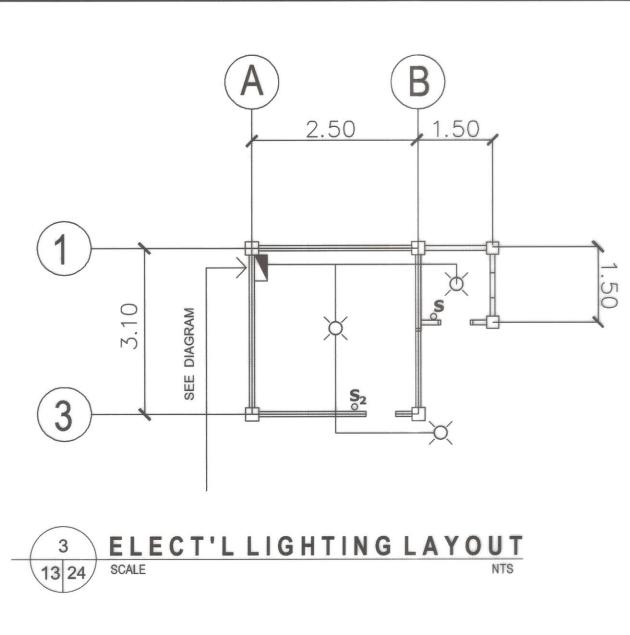

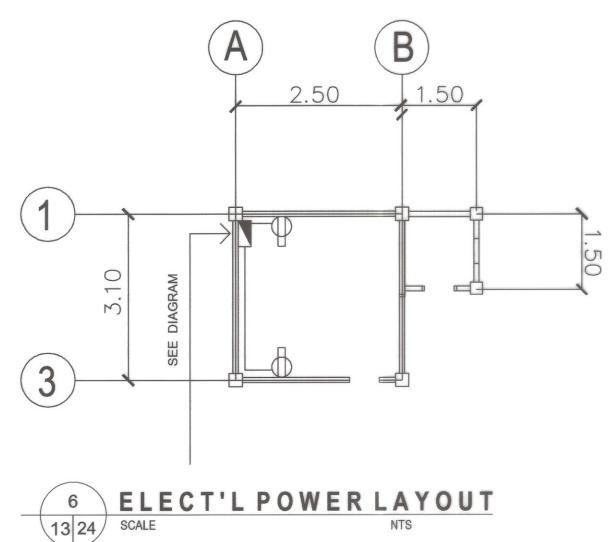

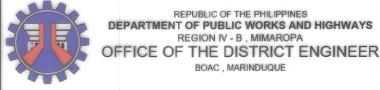



PROJECT NAME AND LOCATION:

CONSTRUCTION OF SOLAR WATER SYSTEM,
BUENAVISTA, MARINDUQUE

DAYKITIN, BUENAVISTA, MARINDUQUE

SOLAR CONTROL ROOM
TYPICAL DRAWINGS

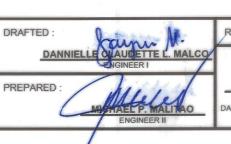

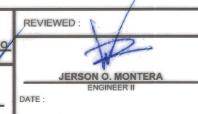



APPROVED :


VACANT


ASSISTANT DISTRICT ENGINEER
DATE :


DIST

EVELYNIR. PUERTOLLANO
DISTRICT ENGINEER


DATE:

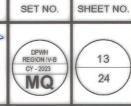


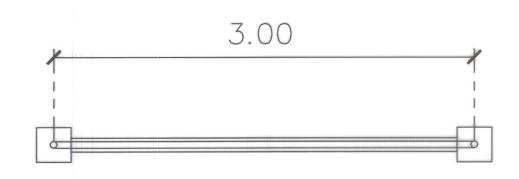


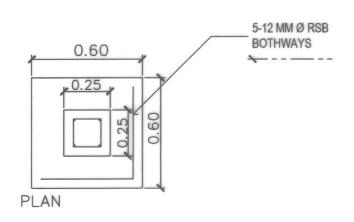




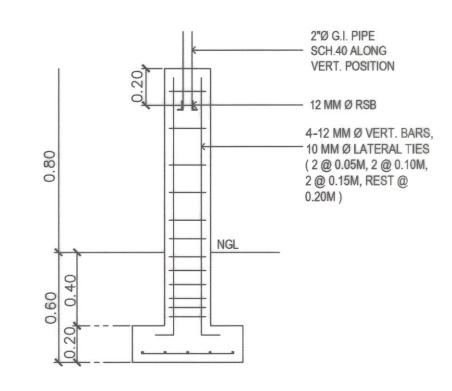

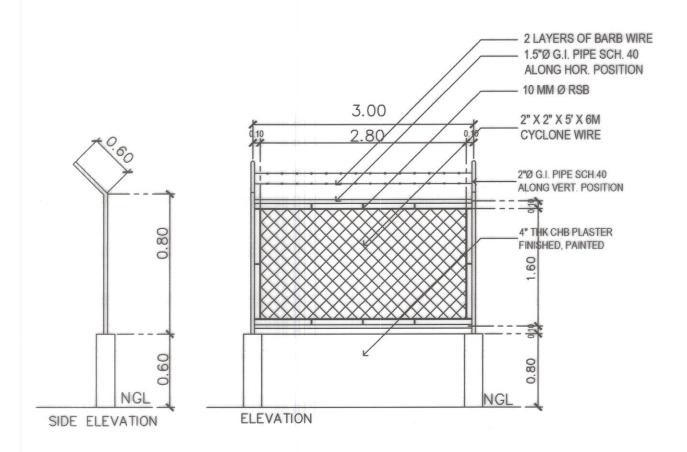

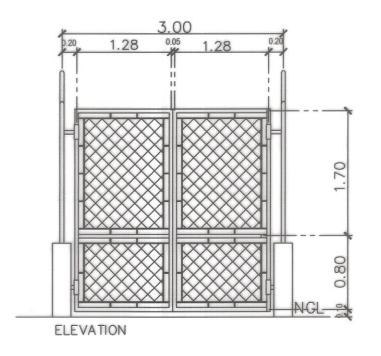



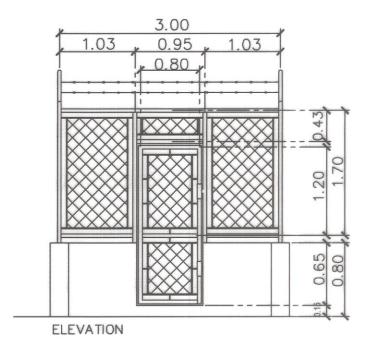



2	FENCED	ETAIL
14 24	SCALE	1:50 MTS


BOAC , MARINDUQUE

1	
IWAYS	CONSTRUCT
NEER	BUEN
	DAYKIT

PROJECT NAME AND LOCATION : TION OF SOLAR WATER SYSTEM, ENAVISTA, MARINDUQUE TIN, BUENAVISTA, MARINDUQUE

DETAIL OF STEEL FENCE TYPICAL DRAWINGS

SHEET CONTENTS:

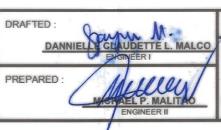

. M.	REVIEWE
ERI MALCO	
Helen/	JI
P. MALITAO GINEER II	DATE:

-	REVIEWED:	S
		Γ
	JERSON O. MONTERA ENGINEER II	۱,
ı	DATE:	DAT

SUBMITTED:	AL
FERN	S. DIAZ
CHIEF, PLANNING DATE:	AND DESIGN SECTION

RECOMMENDED:
VACANT
ASSISTANT DISTRICT ENGINEER DATE:










SET NO. SHEET NO.




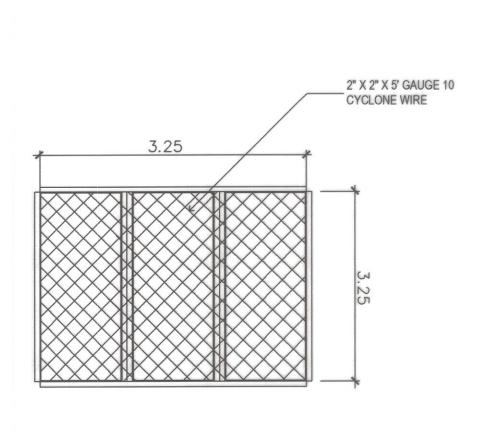


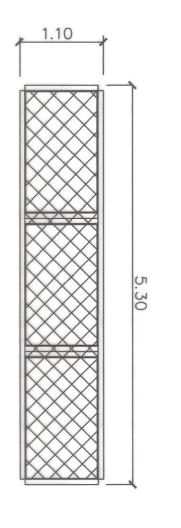

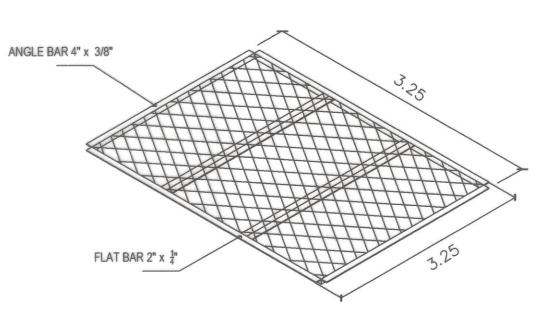

DETAIL OF METAL COVER

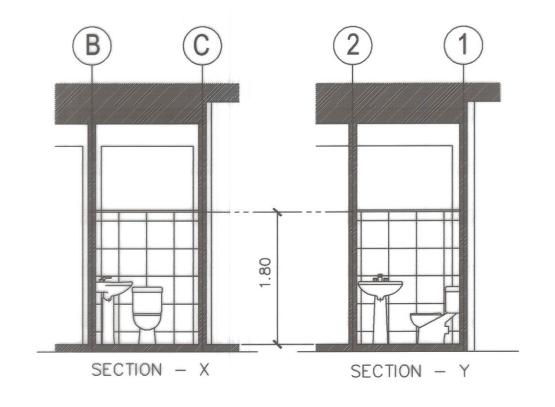


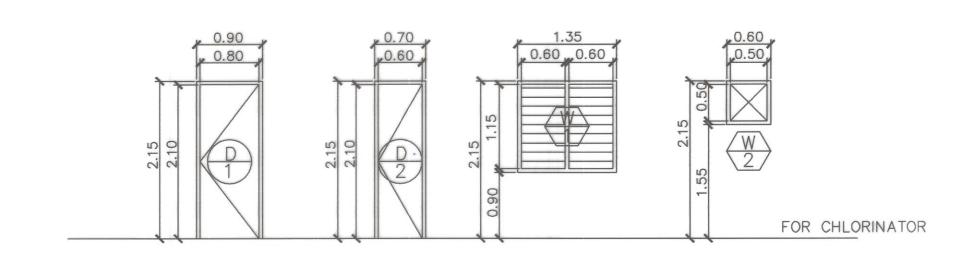


SCHED. OF DOORS & WINDOWS



CONSTRUCTION OF SOLAR WATER SYSTEM, BUENAVISTA, MARINDUQUE
DAYKITIN, BUENAVISTA, MARINDUQUE

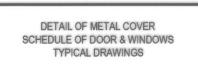

SHEET CONTENTS:

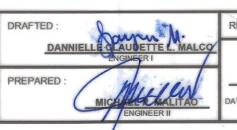



REVIEWED:	SUBMIT
JERSON O. MONTERA	
ENGINEER II DATE :	CHIEF, I

UBMITTED:	A		L
FERN		S. DIAZ	
CHIEF, PLANNIN E :		DESIGN SECTION	


	RECOMMENDED:	APPROVED :
The owner where the party of th	VACANT ASSISTANT DISTRICT ENGINEER DATE:	EVELYN PUERTO DISTRICT ENGINE DATE:



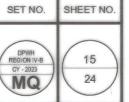


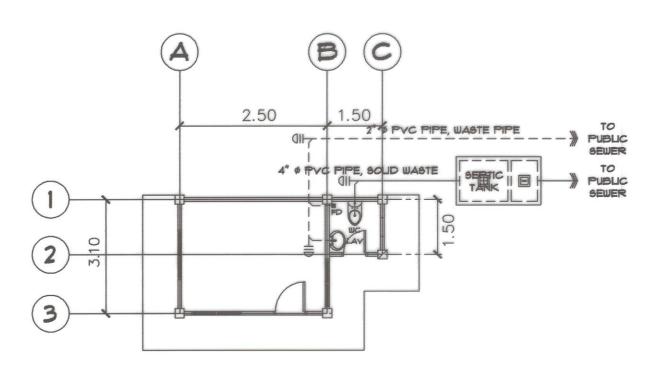



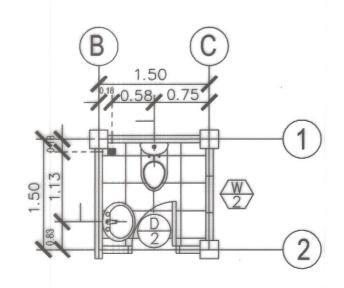




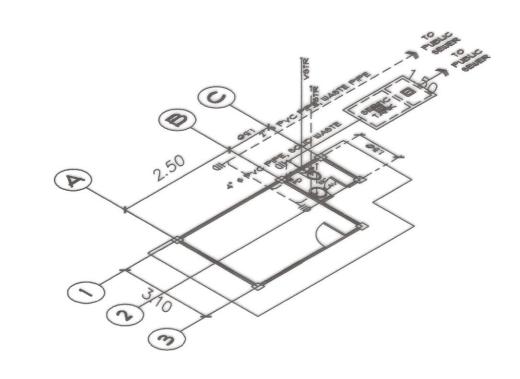


ISO. SEWER LINE LAYOUT 16 24 SCALE

SHEET CONTENTS:

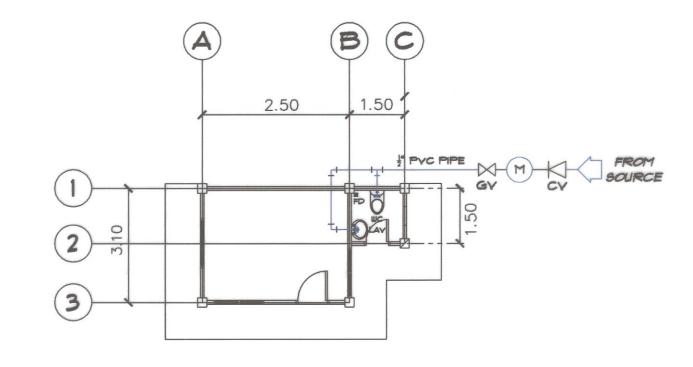




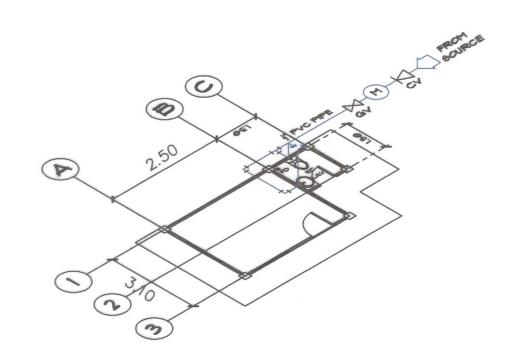


5 ISO. WATER LINE LAYOUT

	REPUBLIC OF THE PHILIPPINES DEPARTMENT OF PUBLIC WORKS AND HIGHWAYS REGION IV - B , MIMAROPA OFFICE OF THE DISTRICT ENGINEER BOAC , MARINDUQUE
--	--

	PROJECT
HIGHWAYS HIGINEER	CONST

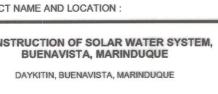

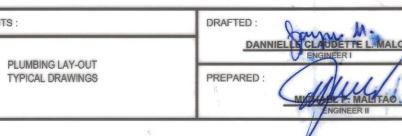



. M.	REVIEWED
ERI	
1.1/1	JEF
MALITAO.	DATE:

	REVIEWED:
0	de
	JERSON O. MONTERA
- 1	ENGINEER II


SUBMITTED:	
FERM	N S. DIAZ
CHIEF, PLANN N DATE :	AND DESIGN SECTION

RECOMMENDED:	
VACANT	
ASSISTANT DISTRICT ENGINEE DATE:	R
DATE:	

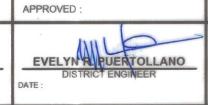

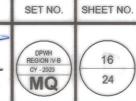



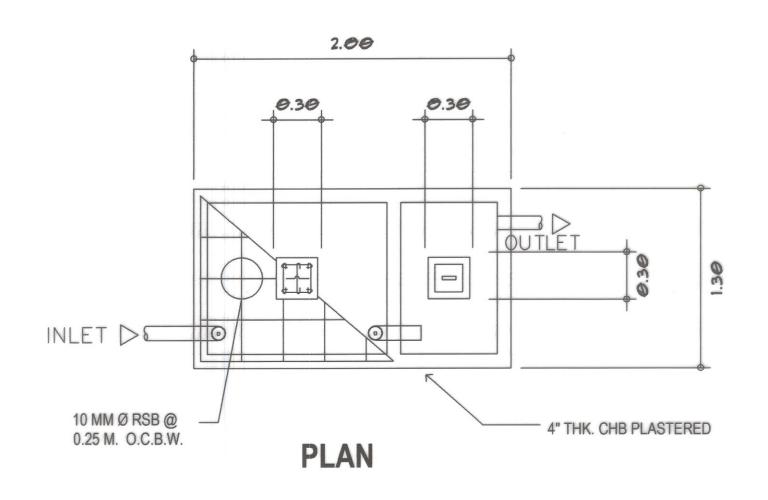


LEGEND


		WATER LINE		FD	FLOOR DRAIN
		SOLID WASTE BASIN LINE		MH	MANHOLE
		WASTE BASIN LINE		WC	WATER CLOSET
\triangle		REDUCER FITTINGS		F	FAUCET
\times	GV	GATE VALVE	A	SHO.	SHOWER
\bigcirc	WM	WATER METER		LAV.	LAVATORY
	*****	WATERWIETER	9/4	C.O.	CLEAN OUT
\triangle	CV	CHECK VALVE		ST	SEPTIC TANK

GENERAL PLUMBING NOTES


- ALL PLUMBING NOTES INCLUDED HEREIN SHALL BE ACCORDANCE WITH THE PROVISION OF THE PLUMBING CODE, NATIONAL BUILDING CODE AND THE LOCAL REGULATIONS OF THE LOCALITY.
- COORDINATE THE DRAWINGS WITH THE OTHER RELATED DRAWINGS AND SPECIFICATIONS. THE ENGINEER AND / OR ARCHITECT SHALL BE NOTIFIED IMMEDIATELY OF ANY DISCREPANCY FOUND HEREIN.
- ALL PIPES SHALL BE INSTALLED AS INDICATED, ANY RELOCATION REQUIRED FOR PROPER EXECUTION OF PLUMBING WORKS SHALL BE WITH THE PRIOR APPROVAL OF THE ENGINEER AND / OR ARCHITECT.
- PROPOSED SANITARY UTILITIES SHALL CONFORM TO THE ACTUAL LOCATION, DEPTH, AND INVERT ELEVATIONS OF ALL EXISTING PIPES AND STRUCTURE AS VERIFIED BY THE CONSTRUCTOR.
- ALL SLOPES FOR HORIZONTAL DRAINAGE SHALL MAINTAIN ONE PERCENT (0.01) AND A HALF (0.008) MINIMUM UNLESS OTHERWISE SPECIFIED.
- WATER SUPPLY PIPE TO FIXTURES SHALL BE SIZED ACCORDANCE WITH THE MANUFACTURERS RECOMMENDATIONS.
- ALL BRANCHES OF FIXTURES OR GROUP OF FIXTURES SHALL BE PROVIDED WITH AIR CHAMBER MADE OF CAPPED VERTICAL EXTENSION PIPE.
- ALL WATER LINES SHALL BE HYDROSTICALLY TESTED AT 100 psi FOR A PERIOD OF TWO (2) HOURS BEFORE BURIED OR COVERED GALVANIZED IRON (G.I.) DIRECTLY IN CONTACT WITH THE SOIL SHALL BE PROVIDED WITHTWO COATS OF ASPHALT.

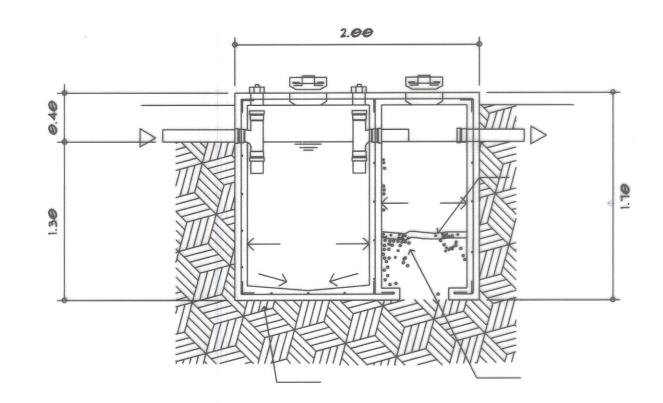




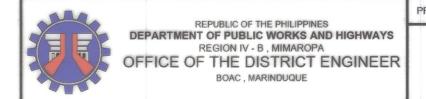

SHEET CONTENTS PROJECT NAME AND LOCATION CONSTRUCTION OF SOLAR WATER SYSTEM, DETAIL OF SEPTIC TANK **BUENAVISTA, MARINDUQUE** GENERAL PLUMBING NOTES PREPARED TYPICAL DRAWINGS DAYKITIN, BUENAVISTA, MARINDUQUE

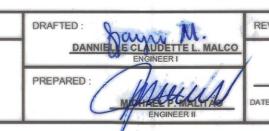

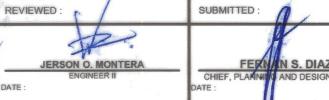

RECOMMENDED

EVELYN R. HUERTOLLANO

SET NO. SHEET NO.


SCHEDULE OF LOADS																				
CIRCUIT	LOAD DESCRIPTION	НР		OUTI	ETS			SWIT	CHE	s	VOLT.	AMD	VOLTS	CPD	BOI	T-O	N	CONDUCTORS	CONDUIT	AREA SERVED
NUMBER		R LOAD DESCRIPTION HP	ne	O.L.	MOTOR	C.O.	L.O.	S	S2	S3	S3W	AMP.	APIF.	VOLIS	AF	P	AT	KAIC	THHN CU STRANDED	COMPOSI
	LIGHTING POINTS AND CONVENIENCE OUTLET				1	3	1	1			660	2.87	230V	50	2	20	10	2 # 3.5 mm ² E= 1 # 3.5 mm ²	20 MMØ	CHLORINATOR


FOR MAIN SERVICE ENTRANCE CONDUCTOR

USE 2NOS. 8.0.0mm² THHN WIRE 1NO. 5.5mm² TW WIRE (G) IN 1Ø 25mm² RSC CONDUIT

FOR MAIN DISCONNECTION EQUIPMENT

USE ONE 30AT, 2P CIRCUIT BREAKER BOLT-ON IN NEMA-1 ENCLOSURE

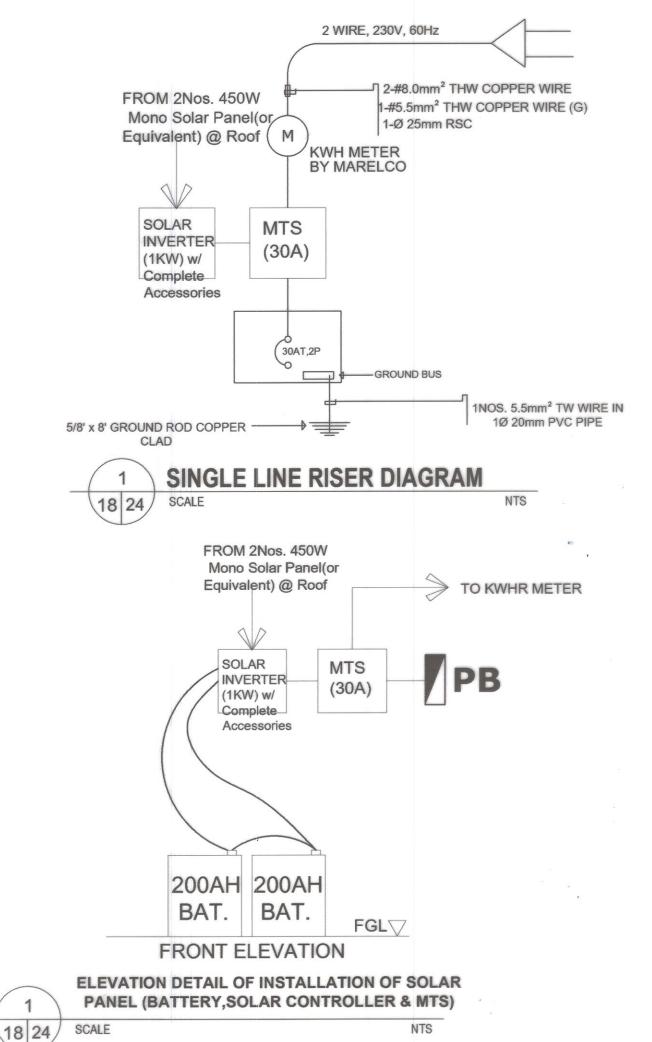

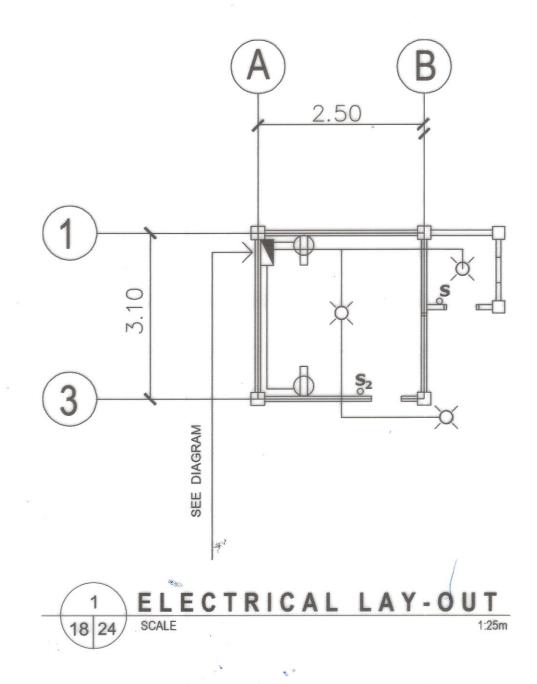

GENERAL NOTES

ALL ELECTRICAL INSTALLATION SHALL BE DONE IN ACCORDANCE WITH THE PROVISIONS OF THE LATEST EDITION OF THE PHILIPPINE ELECTRICAL CODE 2000 EDITION THE LAWS AND ORDINANCES OF THE LOCAL CODE ENFORCING AUTHORITIES AND THE REQUIREMENTS OF THE

SERVICE TO THE BUILDING SHALL BE 230V, 60HZ, SINGLE PHASE, 2-WIRE

MINIMUM SIZE OF CONDUCTORS SHALL BE 230V, 2.00 mm THHN OR TW FOR LIGHTING AND 3.5mm THHN OR TW FOR CONVENIENCE AND POWER CIRCUITS, WITH A MINIMUM CONDUIT OF 20MMØ UPVC

3. WIRING METHOD SHALL BE AS FOLLOWS:

A. RIGID UPVC PIPE FOR RUNS EMBEDDED IN CONCRETE OR UNDERGROUNDS B. RIGID UPVC PIPE WITH APPROVED MEANS OF SUPPORT FOR EXPOSED CONDUIT

C. RIGID UPVC PIPE OR FLEXIBLE UPVC CONDUIT FOR RUNS CONCEALED ON CEILING AND DOUBLE WALLS.

UNLESS OTHERWISE INDICATED, MOUNTING HEIGHTS SHALL BE AS FOLLOWS: LIGHTING SWITCHES ---- 1.40m ABOVE FFL @ CENTER PANEL BOARD 1.50m ---- ABOVE FFL @ CENTER ---- 0.30m ABOVE FFL @ CENTER CONVENIENCE OUTLET SPECIAL PURPOSE OUTLET ---- AS RECOMMENDED BY THE EQUIPMENT MANUFACTURER.

ALL MATERIALS TO BE USED SHALL BE BRAND NEW AND SHALL BE INSTALLED IN APPLICATION FOR WHICH THEY ARE INTENDED.

ALL BOXES FOR ENCLOSURE TO BE INSTALLED OUTDOOR SHALL BE RAIN PROOF 3R RATING OR BE PROVIDED WITH EQUIVALENT PROTECTION.

7. ALL ELECTRICAL INSTALLATION HEREIN SHALL BE DONE UNDER THE SUPERVISION OF A LICENSED ELECTRICAL ENGINEER OR A REGISTERED MASTER ELECTRICIAN.

LEGEND:

SERVICE ENTRANCE

DUPLEX CONVINIENCE OUTLET W/ GROUND AND SHUTTER


CEILING LIGHT OUTLET WITH 15W LED BULB

PANEL BOARD 30AT, 2P CIRCUIT PB BREAKER BOLT-ON IN NEMA-1 **ENCLOSURE**

KWHR METER IN 5METERS CONCRETE PEDESTAL

ONE GANG ONE WAY SWITCH


TWO GANG ONE WAY SWITCH

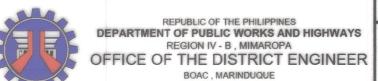

PROJECT NAME AND LOCATION CONSTRUCTION OF SOLAR WATER SYSTEM. **BUENAVISTA, MARINDUQUE** DAYKITIN, BUENAVISTA, MARINDUQUE

SHEET CONTENTS : **ELECTRICAL LAY-OUT** TYPICAL DRAWINGS PREPARED :



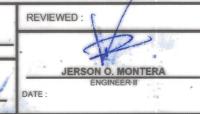





RECOMMENDED


APPROVED EVELYN R PUERTOLLANO





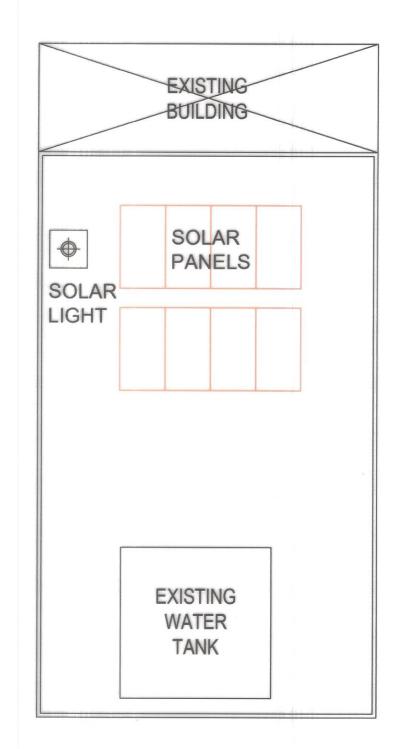

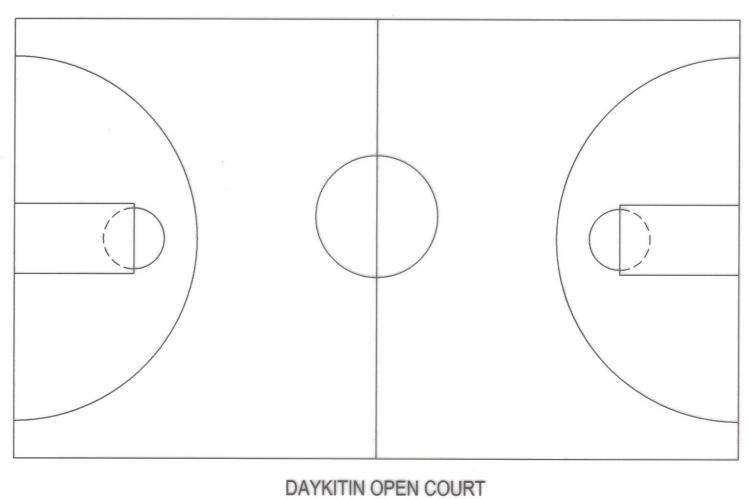


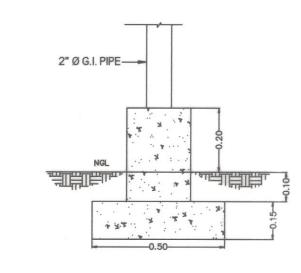


FOUNDATION PLAN 19 24 SCALE



14.

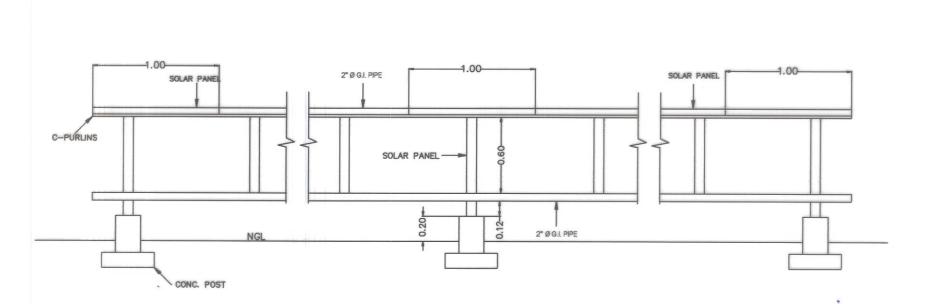

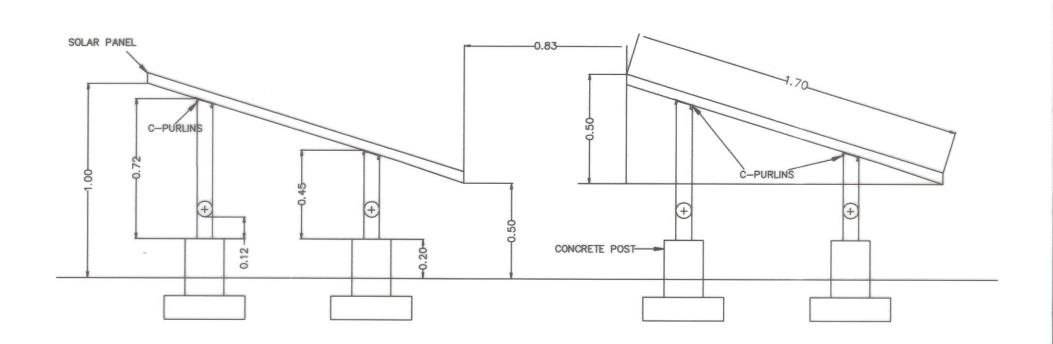

SIDE VIEW PLAN
SCALE 1:40 MTS

. W.		L
	DEPARTMENT OF PUBLIC WORKS AND HIGHWAYS REGION IV - B , MIMAROPA OFFICE OF THE DISTRICT ENGINEER BOAC , MARINDUQUE	

PROJECT NAME AND LOCATION:	SHEET CONTENTS:	DRAFTED:
CONSTRUCTION OF SOLAR WATER SYSTEM, BUENAVISTA, MARINDUQUE DAYKITIN, BUENAVISTA, MARINDUQUE	SOLAR PANEL TYPICAL DRAWINGS	PREPARED:

DETTE L. MALCO NEER I JE NGINEER II DATE:	M	REVIEWE
	VILLA O	JE DATE:


REVIEW	VED:	SUBMITTED:
	JERSON O. MONTERA	FERNA
DATE :	ENGINEER II	CHIEF, PLANNING A DATE:

·	RECOMMENDED:	
IAZ SIGN SECTION	VACANT ASSISTANT DISTRICT ENC	

	EVELYN R PUERTOLLAN
NGINEER	DISTRICT ENGINEER DATE:





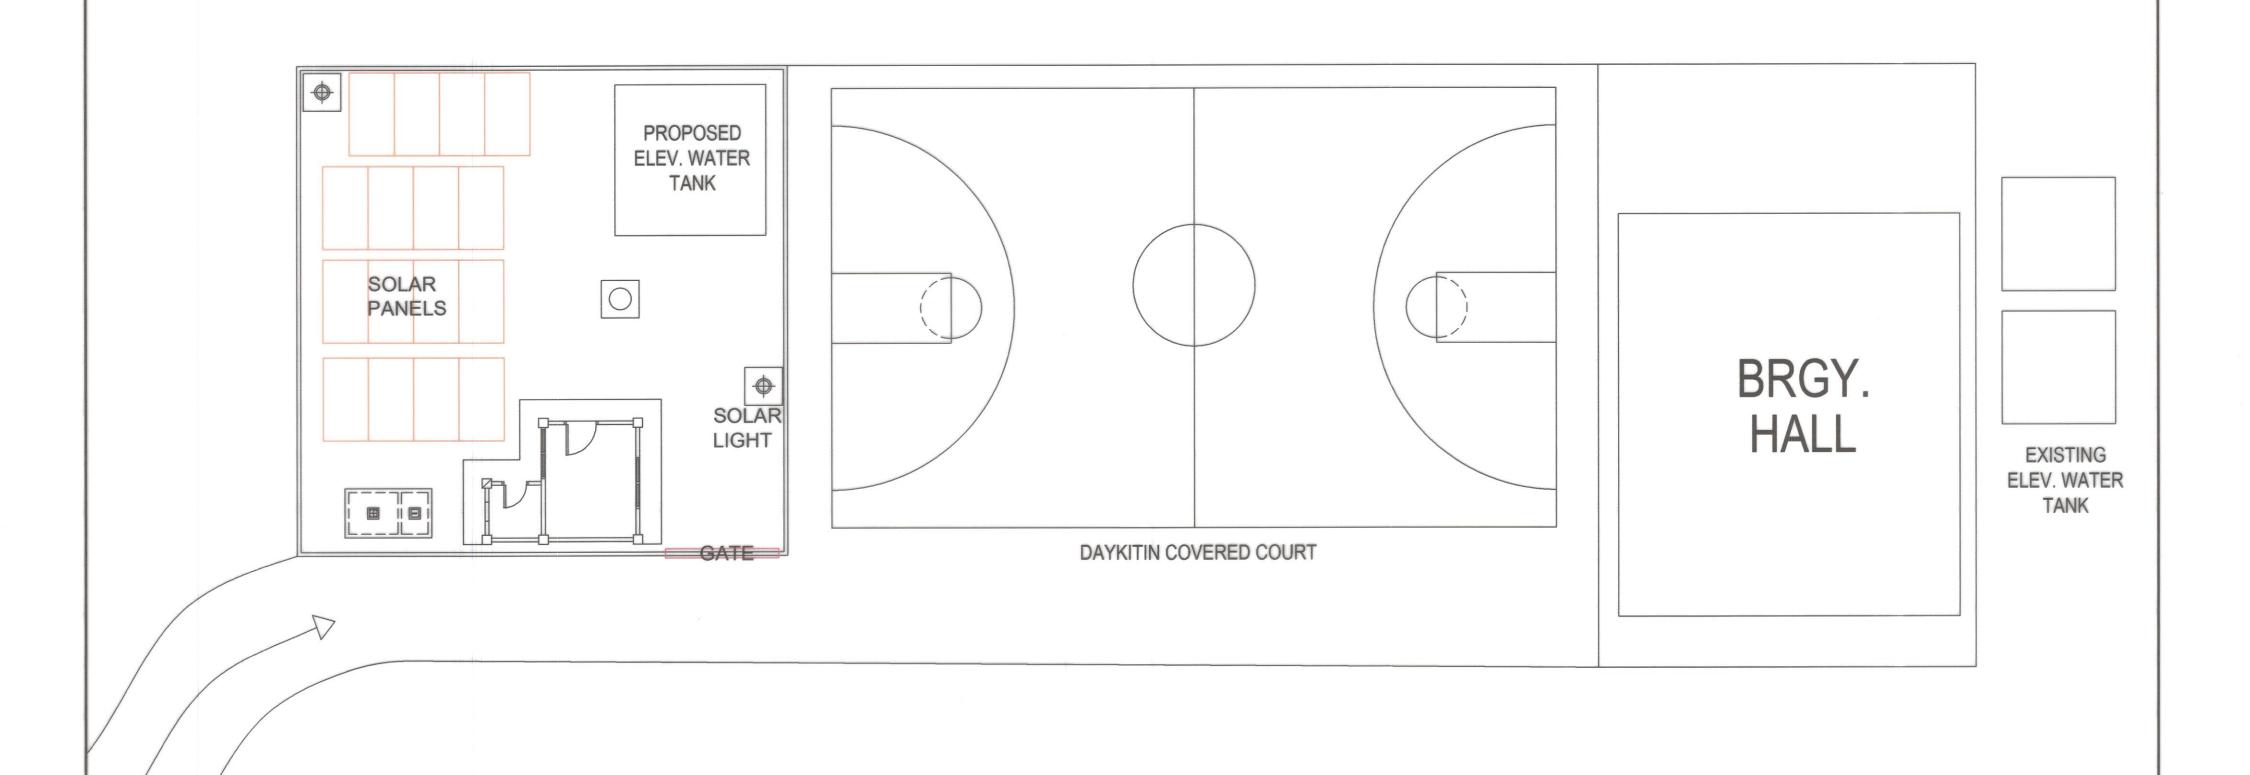




REPUBLIC OF THE PHILIPPINES

DEPARTMENT OF PUBLIC WORKS AND HIGHWAYS REGION IV - B , MIMAROPA OFFICE OF THE DISTRICT ENGINEER BOAC, MARINDUQUE

PROJECT NAME AND LOCATION: CONSTRUCTION OF SOLAR WATER SYSTEM, **BUENAVISTA, MARINDUQUE** DAYKITIN, BUENAVISTA, MARINDUQUE

SOLAR PANEL TYPICAL DRAWINGS

SHEET CONTENTS:

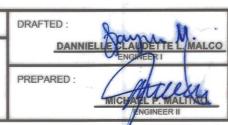

	REVIEWED:	
0		
	JERSON O. MONTERA ENGINEER II	
	DATE:	
-	DATE:	

	SUBMITTED:	
-	FERMA CHIEF, PLANNING	S. DIAZ ND DESIGN SECTION

REC	OMMENDED :
	VACANT
DATE :	ASSISTANT DISTRICT ENGINEER

APPROVED:



20


LED SOLAR LAMP SPECIFICATIONS OVERVIEW

LAMP BRIGHTNESS	70 WATTS
LED STRUCTURE	200PCS IN 4 LED PCB 50X4 SMD 3030 BAT-WING POLARIZED LENS 120 DEGREES VIEWING ANGLE
LUMENS	8,000 - 10,000 LUMENS
LIFESPAN	50,000 HOURS
ССТ	6000K COLOR TEMPERATURE
CHARGE CONTROLLER	MPPT, 30A CHARGE CURRENT INTELLIGENT LED POWER CONTROL W/ 120W MAXIMUM OUTPUT POWER AND 10-STEP LOAD WORKING MODE
BATTERY	360WH, ORIGINAL LIFEPO4 (LITHIUM ION PHOSPHATE), GREATER THAN 3000 CYCLES AT 80% DOD, W/ 20% AGING FACTOR
SOLAR PANEL	MONOCRYSTALLINE, 90W, CELL EFFICIENCY GREATER 18%, GREATER THAN 70% FILL FACTOR TEMPERED GLASS
BODY MATERIAL	HIGH-PRESSURE DIE-CAST ALUMINUM ALLOY, IP65 ENCLOSURE
BODY COLOR	EPOXY PAINT DARK GREY COLOR CASING W/ COLLAR LIGHT(BLUE LED)
WIND STRENGTH	60M/S OR 200KG PER SQM EPA NOT MORE THAN 0.5 SQ.M
DIMENSION	LENGTH: 1000-1100MM WIDTH: 500-550MM THICKNESS: 140-150MM
WORKING TIME	12 HRS ; 3-5 CLOUDY / RAINY DAYS
CHARGING TIME	6 HOURS EFFECTIVE SUNSHINE
TOTAL WEIGHT	LESS THAN 25KG
WARRANTY	5 YEARS



ARM DIAMETER	3 INCHES
TOP DIAMETER	3 INCHES
BOTTOM DIAMETER	6 INCHES
TOTAL POLE HEIGHT	6 METERS
ARM LENGTH	1.5 METERS
BASE PLATE	320MMX320MMX16MM
FINISH	HOT DIP GALVANIZED



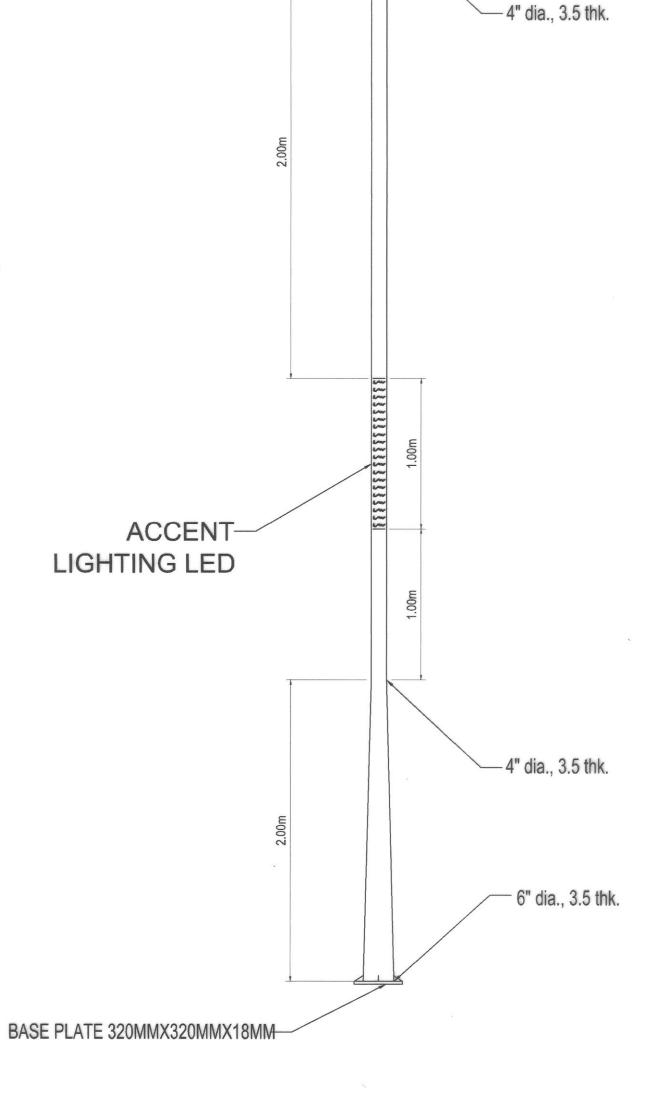



PROJECT NAME AND LOCATION: CONSTRUCTION OF SOLAR WATER SYSTEM, **BUENAVISTA, MARINDUQUE** DAYKITIN, BUENAVISTA, MARINDUQUE

SOLAR LAMP SPECIFICATIONS TYPICAL DRAWINGS


SHEET CONTENTS:


PREPARED:

3" dia., 3.5 thk.

RECOMMENDED: APPROVED: EVELYN R PUERTOLLANO DISTRICT ENGINEER

SET NO. SHEET NO.

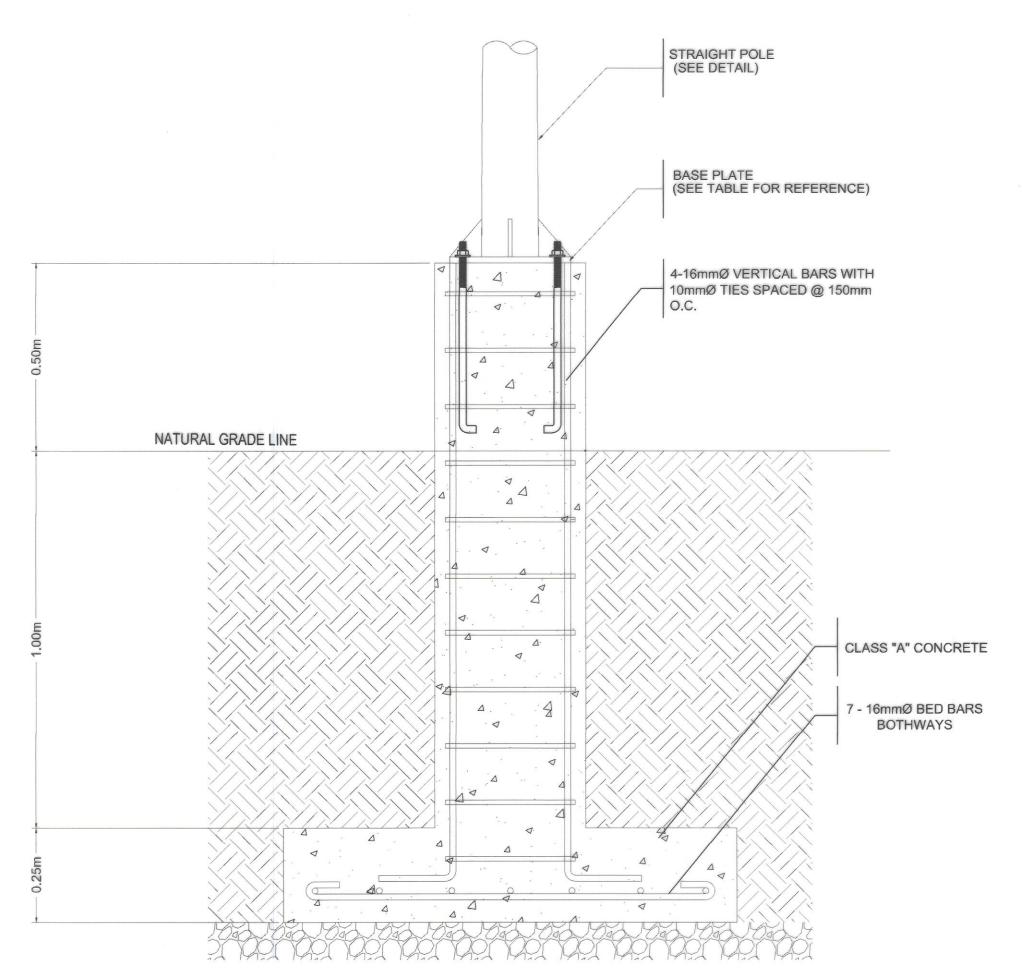

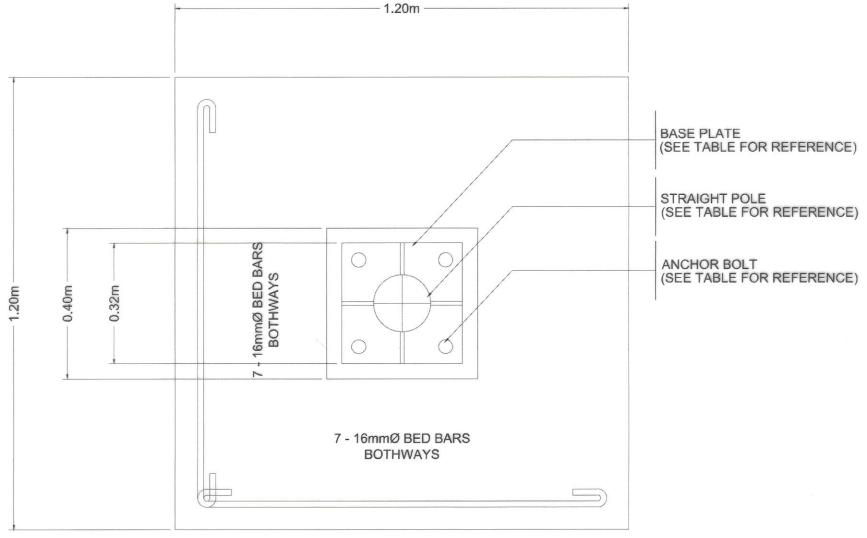

2 DETAIL OF FOOTING
23 24 SCALE 1: 10m

1 DETAIL OF PEDESTAL
23 24 SCALE 1: 10m

REPUBLIC OF THE PHILIPPINES

DEPARTMENT OF PUBLIC WORKS AND HIGHWAYS

REGION IV - B , MIMAROPA

OFFICE OF THE DISTRICT ENGINEER

BOAC , MARINDUQUE

CONSTRUCTION OF SOLAR WATER SYSTEM,
BUENAVISTA, MARINDUQUE

DAYKITIN, BUENAVISTA, MARINDUQUE

SOLAR LIGHT TYPICAL DRAWINGS

SHEET CONTENTS:

DRAFTED:

DANNIE LE GLAUDETTE L. MALCO
EN MEET I

PREPARED:

MIGHAEL F. MALITAO

ENGINEER II

REVIEWED:

JERSON

DATE:

JERSON O. MONTERA
ENGINEER II

FERNANS. DIAZ
HIEF, PLANNING IND DESIGN SECTION
E:

SUBMITTED:

VACANT

ASSISTANT DISTRICT ENGINEER
DATE:

RECOMMENDED:


EVELYN R PUER OLLANO
DISTRICT ENGINEER
DATE:

APPROVED:

| DPMH | REGION IV-B | CY-2023 | MQ | 24

SHEET NO.

SET NO.

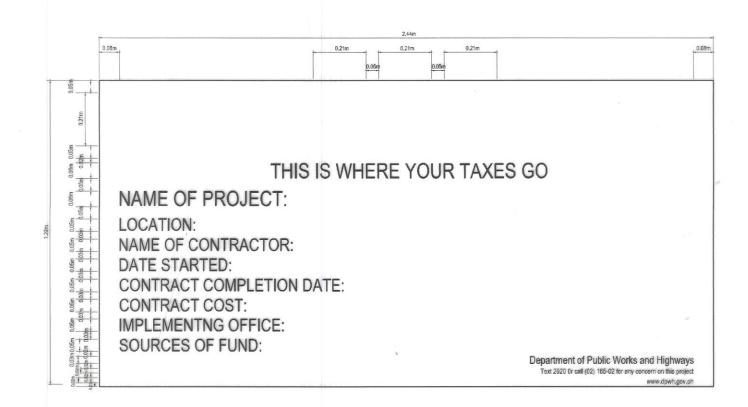






DETAIL OF BILLBOARD

NOTES:

- 1. THE INSTALLATION OF THE REQUIRED STANDARD BILLBOARD SIZE (1200MM X 2400MM / 4 FT. X 8FT.) FOR ALL PROJECTS SHALL BE STRICTLY ENFORCED.
- 2. NO POLITICAL BILLBOARDS SHALL BE ALLOWED TO BE INSTALLED 100 METERS BEFORE AND 100 METERS AFTER ALL DPWH PROJECTS AND IN BETWEEN THE PROJECT LIMITS OR WITHIN THE ROAD RIGHT OF WAY.
- 3. DPWH CONTRACTORS SHALL NOT BE ALLOWED TO PLACE NAMES OF POLITICIANS ON THEIR EQUIPMENT OR CARRY POLITICAL BILLBOARD ON THEIR EQUIPMENT.

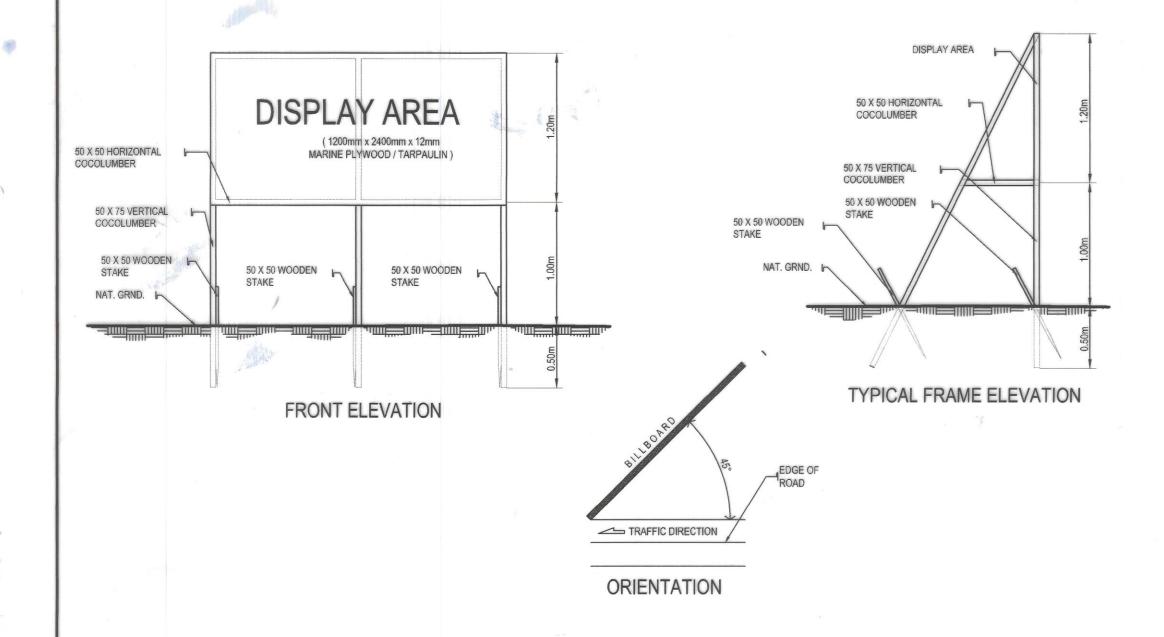


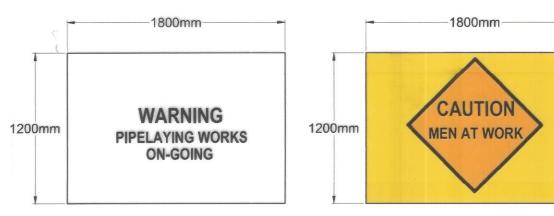

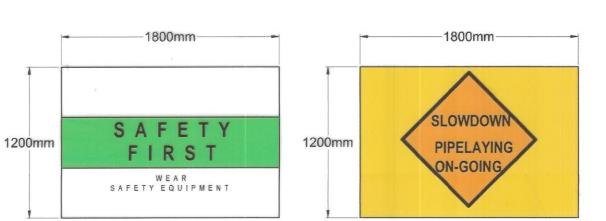






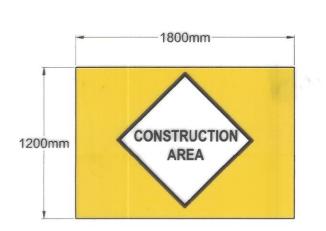



WATERWORKS CONSTRUCTION SIGNAGE

NOTE: SIGNS SHALL BE MADE FROM RETROFLECTIVE SIGN FACE MATERIAL AS PER DO 13 SERIES OF 2018

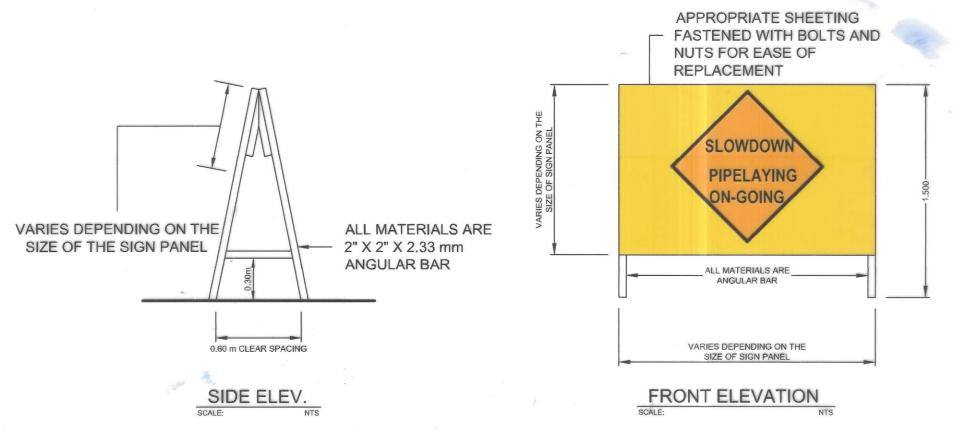


SIGNAGE INSTALLATION DETAIL



	PRC
D HIGHWAYS	
NGINEER	



SHEET CONTENTS:

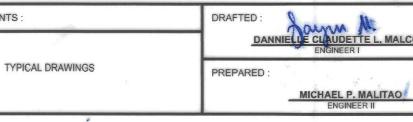

	REVIEWED:
0	
	JERSON O. MONTERA ENGINEER II
.	DATE:

	SUBMITTED:
ı	FERNAN S. DIAZ
ı	CHIEF, PLANNING AND DESIGN SECTION

RECOMMENDED:	
-	VACANT
-	ASSISTANT DISTRICT ENGINEER
NATE	

