

REPUBLIC OF THE PHILIPPINES

DEPARTMENT OF PUBLIC WORKS AND HIGHWAYS

REGION IV-B, MIMAROPA
OFFICE OF THE DISTRICT ENGINEER
BOAC, MARINDUQUE

C.Y. 2023 PROJECT

DETAILED ENGINEERING DESIGN PLAN FOR CONSTRUCTION OF WATER SUPPLY SYSTEM, BARANGAY CAGANHAO, BOAC, MARINDUQUE

BOAC, MARINDUQUE

SUBMITTED:

FERNAN S. DIAZ
CHIEF, PLANNING AND DESIGN SECTION

RECOMMENDED:

DATE:


ARISTEO L. LINGA ASSISTANT DISTRICT ENGINEER APPROVED:

EVELYN R. PUERTOLLANO DISTRICT ENGINEER


DATE:

	INDEX OF SHEET	
CATEGORY	DESCRIPTION	SHEET NO.
	FRONT PAGE	1
	INDEX OF SHEET & SUMMARY OF QUANTITIES	2
arura.	KEY MAP & LOCATION MAP	2
GENERAL	LOCATION PLAN	3
	TYPICAL DRAWINGS	4 - 12

ITEM NO.	DESCRIPTION	ORIGINAL QUANTITY	UNIT	REMARKS
PART A:	FACILITIES FOR THE ENGINEER			
A.1.1(8)	PROVISION OF FIELD OFFICE FOR THE ENGINEER (RENTAL BASIS)	3.17	mos.	
A.1.2(4)	PROVISION OF FIELD 4x2 PICK UP TYPE SERVICE VEHICLE FOR THE ENGINEER ON BARE RENTAL BASIS	3.17	mos.	
PART B:	OTHER GENERAL REQUIREMENTS			
B.4(10)	MISCELLANEOUS SURVEY AND STAKING	1.00	LS	Staked Plan To be submitted by the contractor
B.5	PROJECT BILLBOARD / SIGNBOARD	1.00	each	DPWH Standard Billboard
B.7(2)	OCCUPATIONAL SAFETY AND HEALTH PROGRAM	1.00	LS	Includes Personal Protective Equipment (PPE), Safety Signages and Health Program
B.9	MOBILIZATION / DEMOBILIZATION	1.00	LS	
PART C:	EARTHWORKS			
803(1)a	STRUCTURE EXCAVATION (COMMON SOIL)	16.60	m³	For Foundation and Pipelines
804(4)	GRAVEL FILL	2.16	m³	For Concrete Foundation
PART D:	PLAIN AND REINFORCED CONCRETE WORKS			
900(1)c2	STRUCTURAL CONCRETE FOR FOOTING AND SLAB (CLASS A, 28 DAYS)	34.60	m³	For Elevated Water Tank & Pump Motor House
902(1)a	REINFORCING STEEL (DEFORMED), GRADE 40	3,044.61	kgs	For Pump Motor House
903(2)	FORMWORKS AND FALSEWORKS	123.08	m ²	For Water Tank
PART E:	FINISHING WORKS			
1027(1)	CEMENT PLASTER FINISH	160.20	m ²	For Elevated Water Tank & Pump Motor House
1046(2)a1	100MM CHB NON-LOAD BEARING (INCLUDING REINFORCING STEEL)	21.60	m ²	For Elevated Water Tank & Pump Motor House
1032(1)a	PAINTING WORKS (MASONRY CONCRETE)	140.05	m ²	For Elevated Water Tank & Pump Motor House
1032(1)c	PAINTING WORKS (STEEL)	18.80	m ²	For Elevated Water Tank & Pump Motor House
1018(1)	GLAZED TILES AND TRIMS	45.00	m ²	For Elevated Water Tank & Pump Motor House
1047(1)	STRUCTURAL STEEL	1.00	LS	For Elevated Water Tank & Pump Motor House
PART F:	PLUMBING WORKS			
1201(1)	WATER PUMPING SYSTEM	1.00	LS	For Pipe Drilling & Pump Motor House
1001(10)	PIPES WITH FITTINGS CONNECTION	1.00	LS	
1602(5)	POLYETHYLENE PLASTIC PIPE (HDPE)	1,00	LS	For Distribution Line
1603(1)	VALVE	1.00	LS	
1002(27)	PLUMBING WORKS	1.00	LS	
PART G:	ELECTRICAL WORKS			
1100(10)	CONDUIT, BOXES, AND FITTINGS (CONDUIT WORKS/CONDUIT ROUGH-IN)	1.00	LS	For Pump Motor House
1101(33)	WIRES AND WIRING DEVICES	1.00	LS	For Pump Motor House
1102(1)	PANEL BOARD WITH MAIN & BRANCHES BREAKERS	1.00	LS	For Pump Motor House
1103(1)	LIGHTING FIXTURES AND LAMPS	1.00	LS	For Pump Motor House

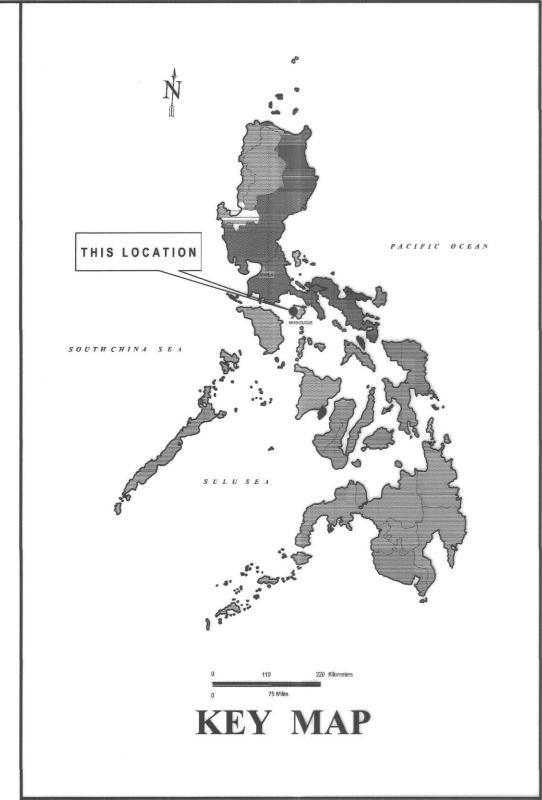



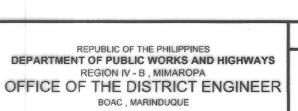

PROJECT NAME AND LOCATION :

CONSTRUCTION OF WATER SUPPLY SYSTEM,
BARANGAY CAGANHAO, BOAC, MARINDUQUE

BOAC, MARINDUQUE

INDEX OF SHEETS SUMMARY OF QUANTITIES KEY MAP LOCATION MAP

SHEET CONTENTS:

DRAFTED:

ARTHUR M. JARDELEZA
ENGINEERING ASSISTANT

PREPARED:

MICHAELP, MALTINO
ENGINEER II

JERSON O. MONTERA
ENGINEER II

FERNAN S. DIAZ

CHIEF, PLANNING AND DESIGN SECTION DATE:

SUBMITTED:

ARISTEO L. LINGA
ASSISTANT DISTRICT ENGINEER
DATE:

RECOMMENDED:


EVELYN R. RUERTOLLA

DISTRICT ENGINEER


DATE:

DPWH REGION IV-B CY-2023


SET NO. SHEET NO.

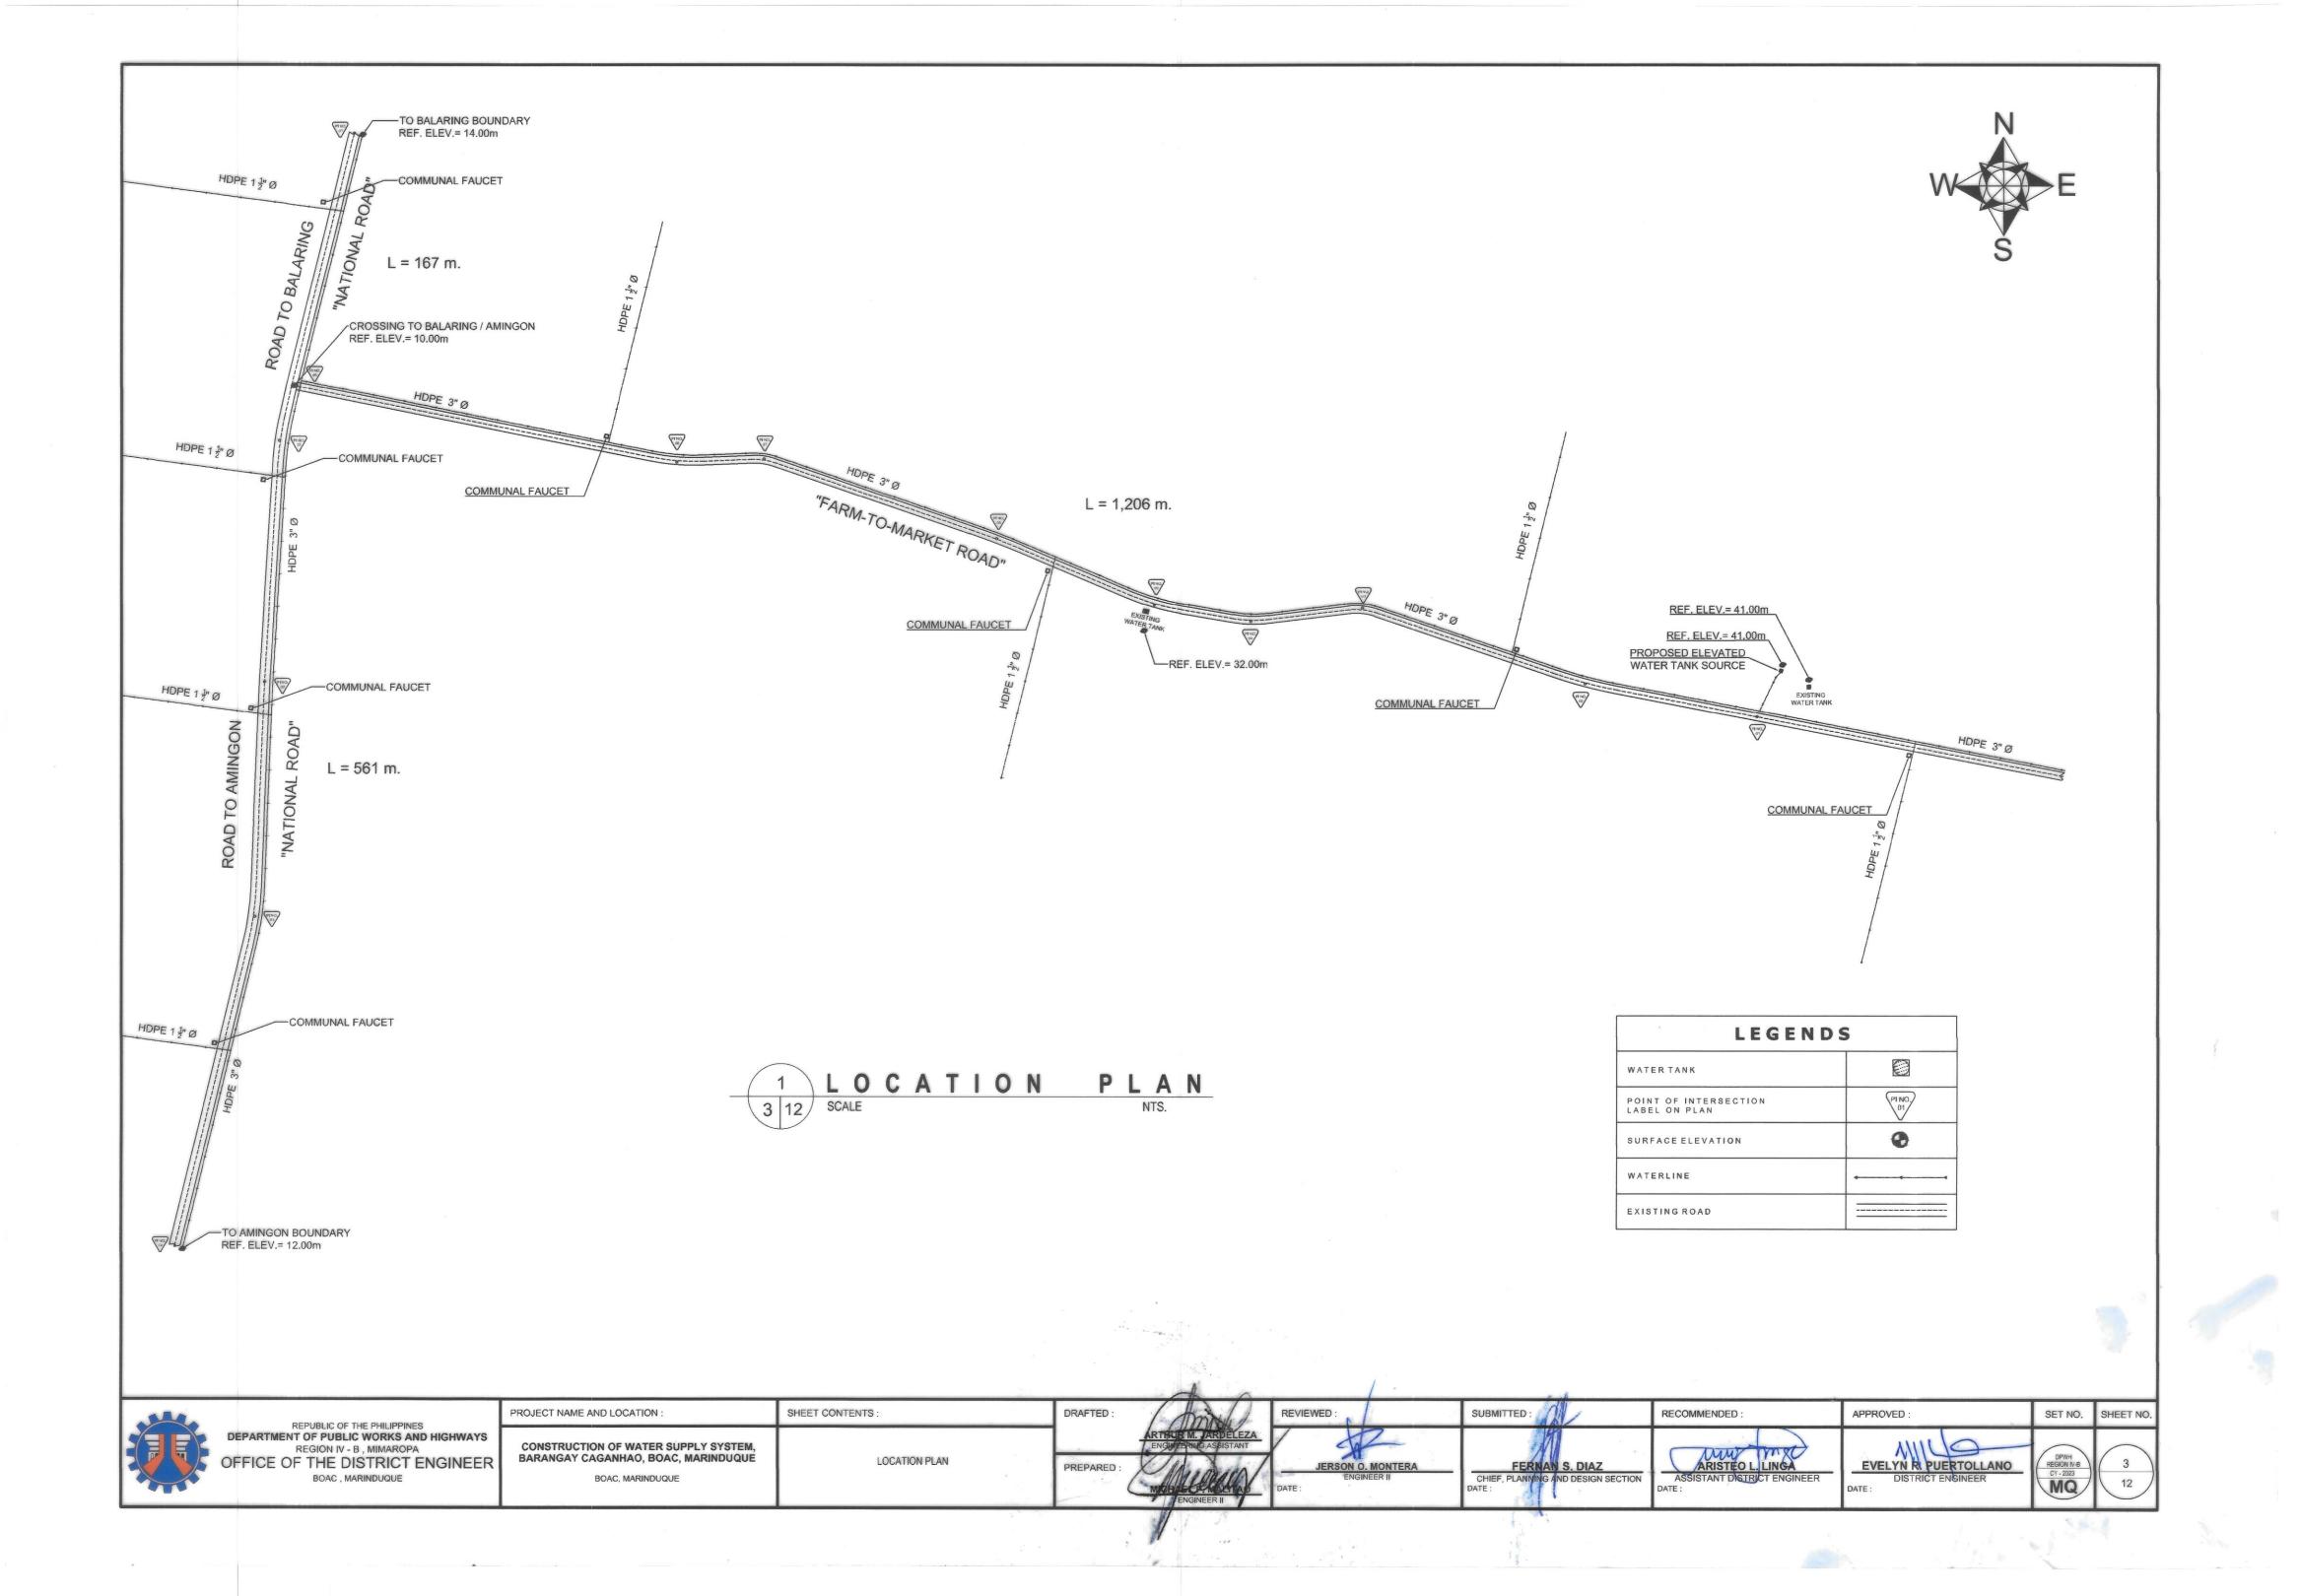

TYPICAL ROADWAY SECTION

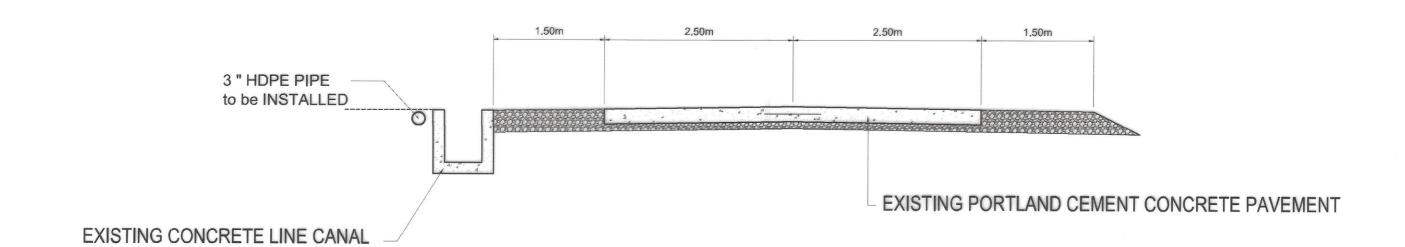





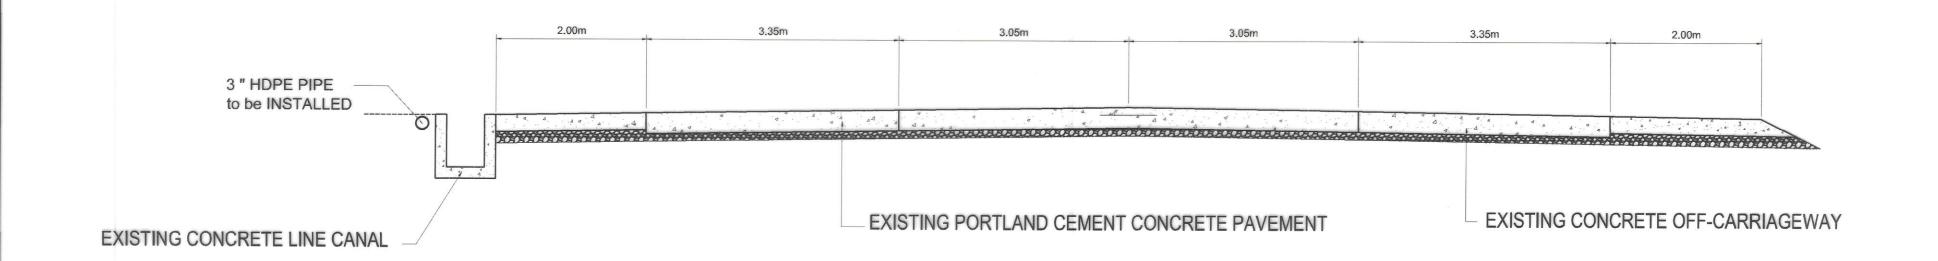



REPUBLIC OF THE PHILIPPINES	PROJECT NAME AND LOCATION :	SHEET CONTENTS:	DRAFTED:	REVIEWED :	SUBMITTED:	RECOMMENDED:	APPROVED :	SET NO.	SHEET NO.
DEPARTMENT OF PUBLIC WORKS AND HIGHWAYS REGION IV - B , MIMAROPA OFFICE OF THE DISTRICT ENGINEER BOAC , MARINDUQUE	CONSTRUCTION OF WATER SUPPLY SYSTEM, BARANGAY CAGANHAO, BOAC, MARINDUQUE BOAC, MARINDUQUE	TYPICAL DRAWINGS	PREPARED:	JERSON O. MONTERA ENGINEER II DATE:	FERNAN S. DIAZ CHIEF, PLANNING AND DESIGN SECTION DATE:	ARISTEOL LINGA ASSISTANT DISTRICT ENGINEER DATE:	EVELYN R PUERTOLLANO DISTRICT ENGINEER DATE:	DPWH REGION IV-B CY-2023	4 12

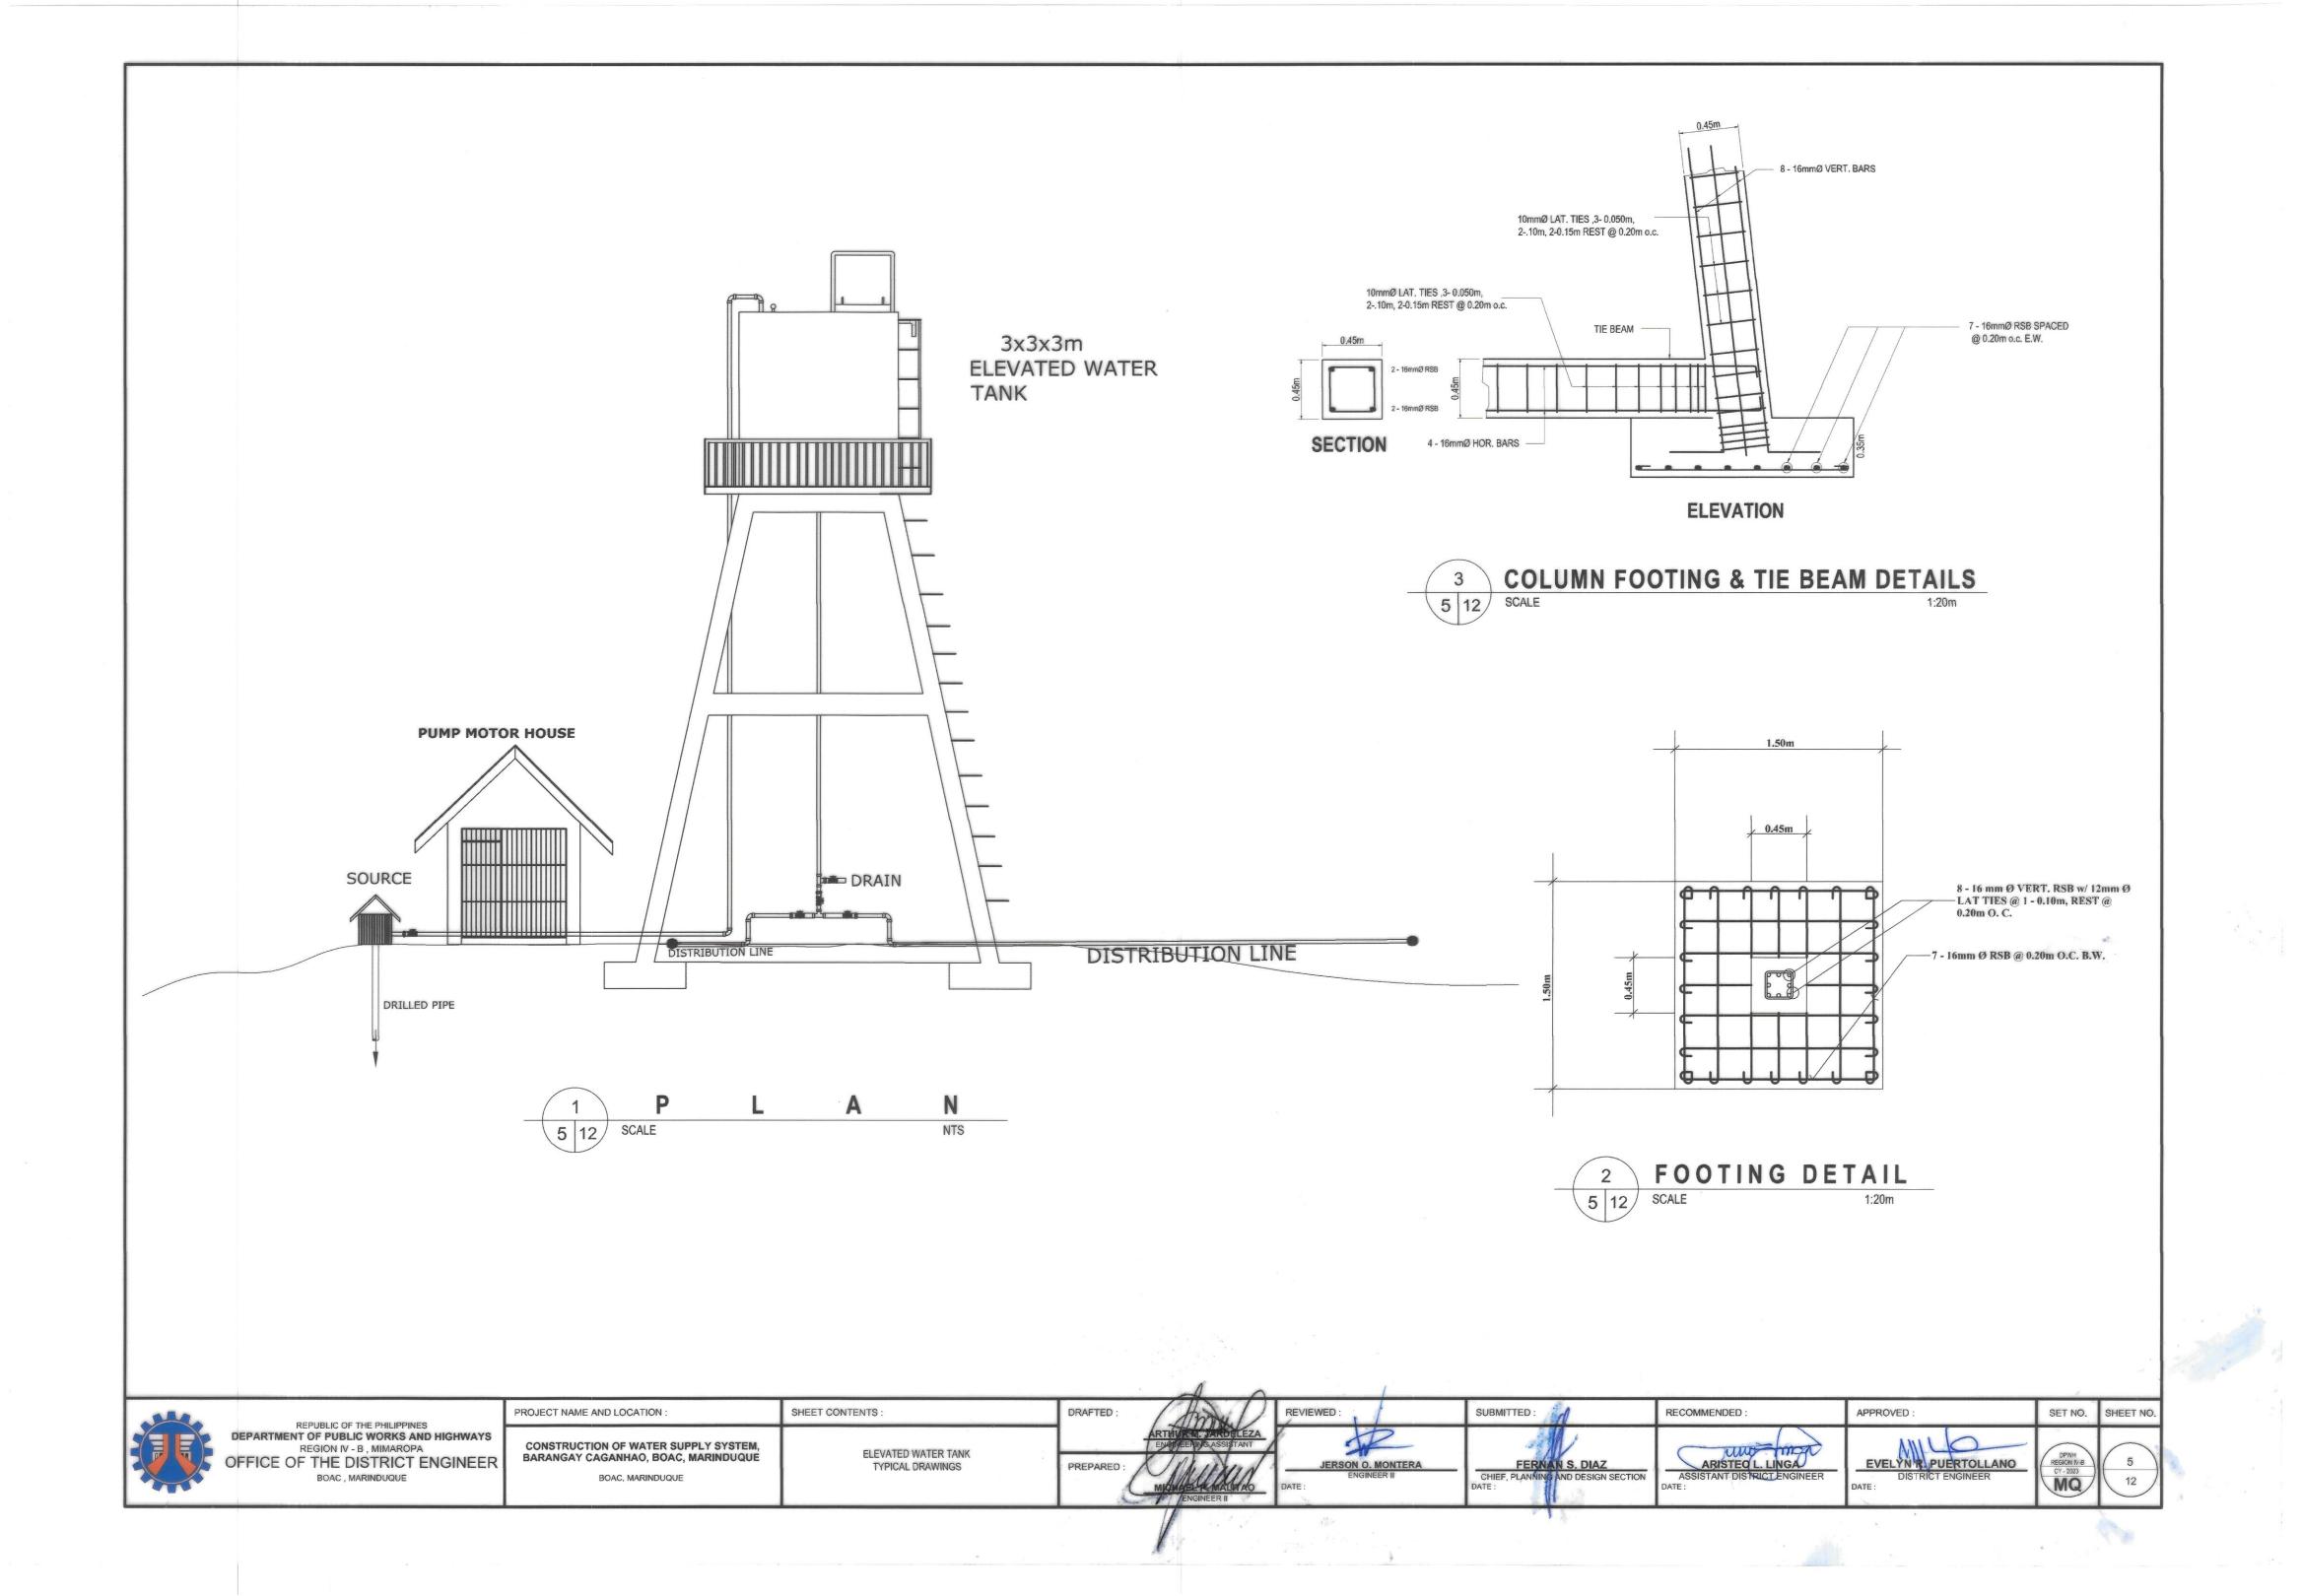

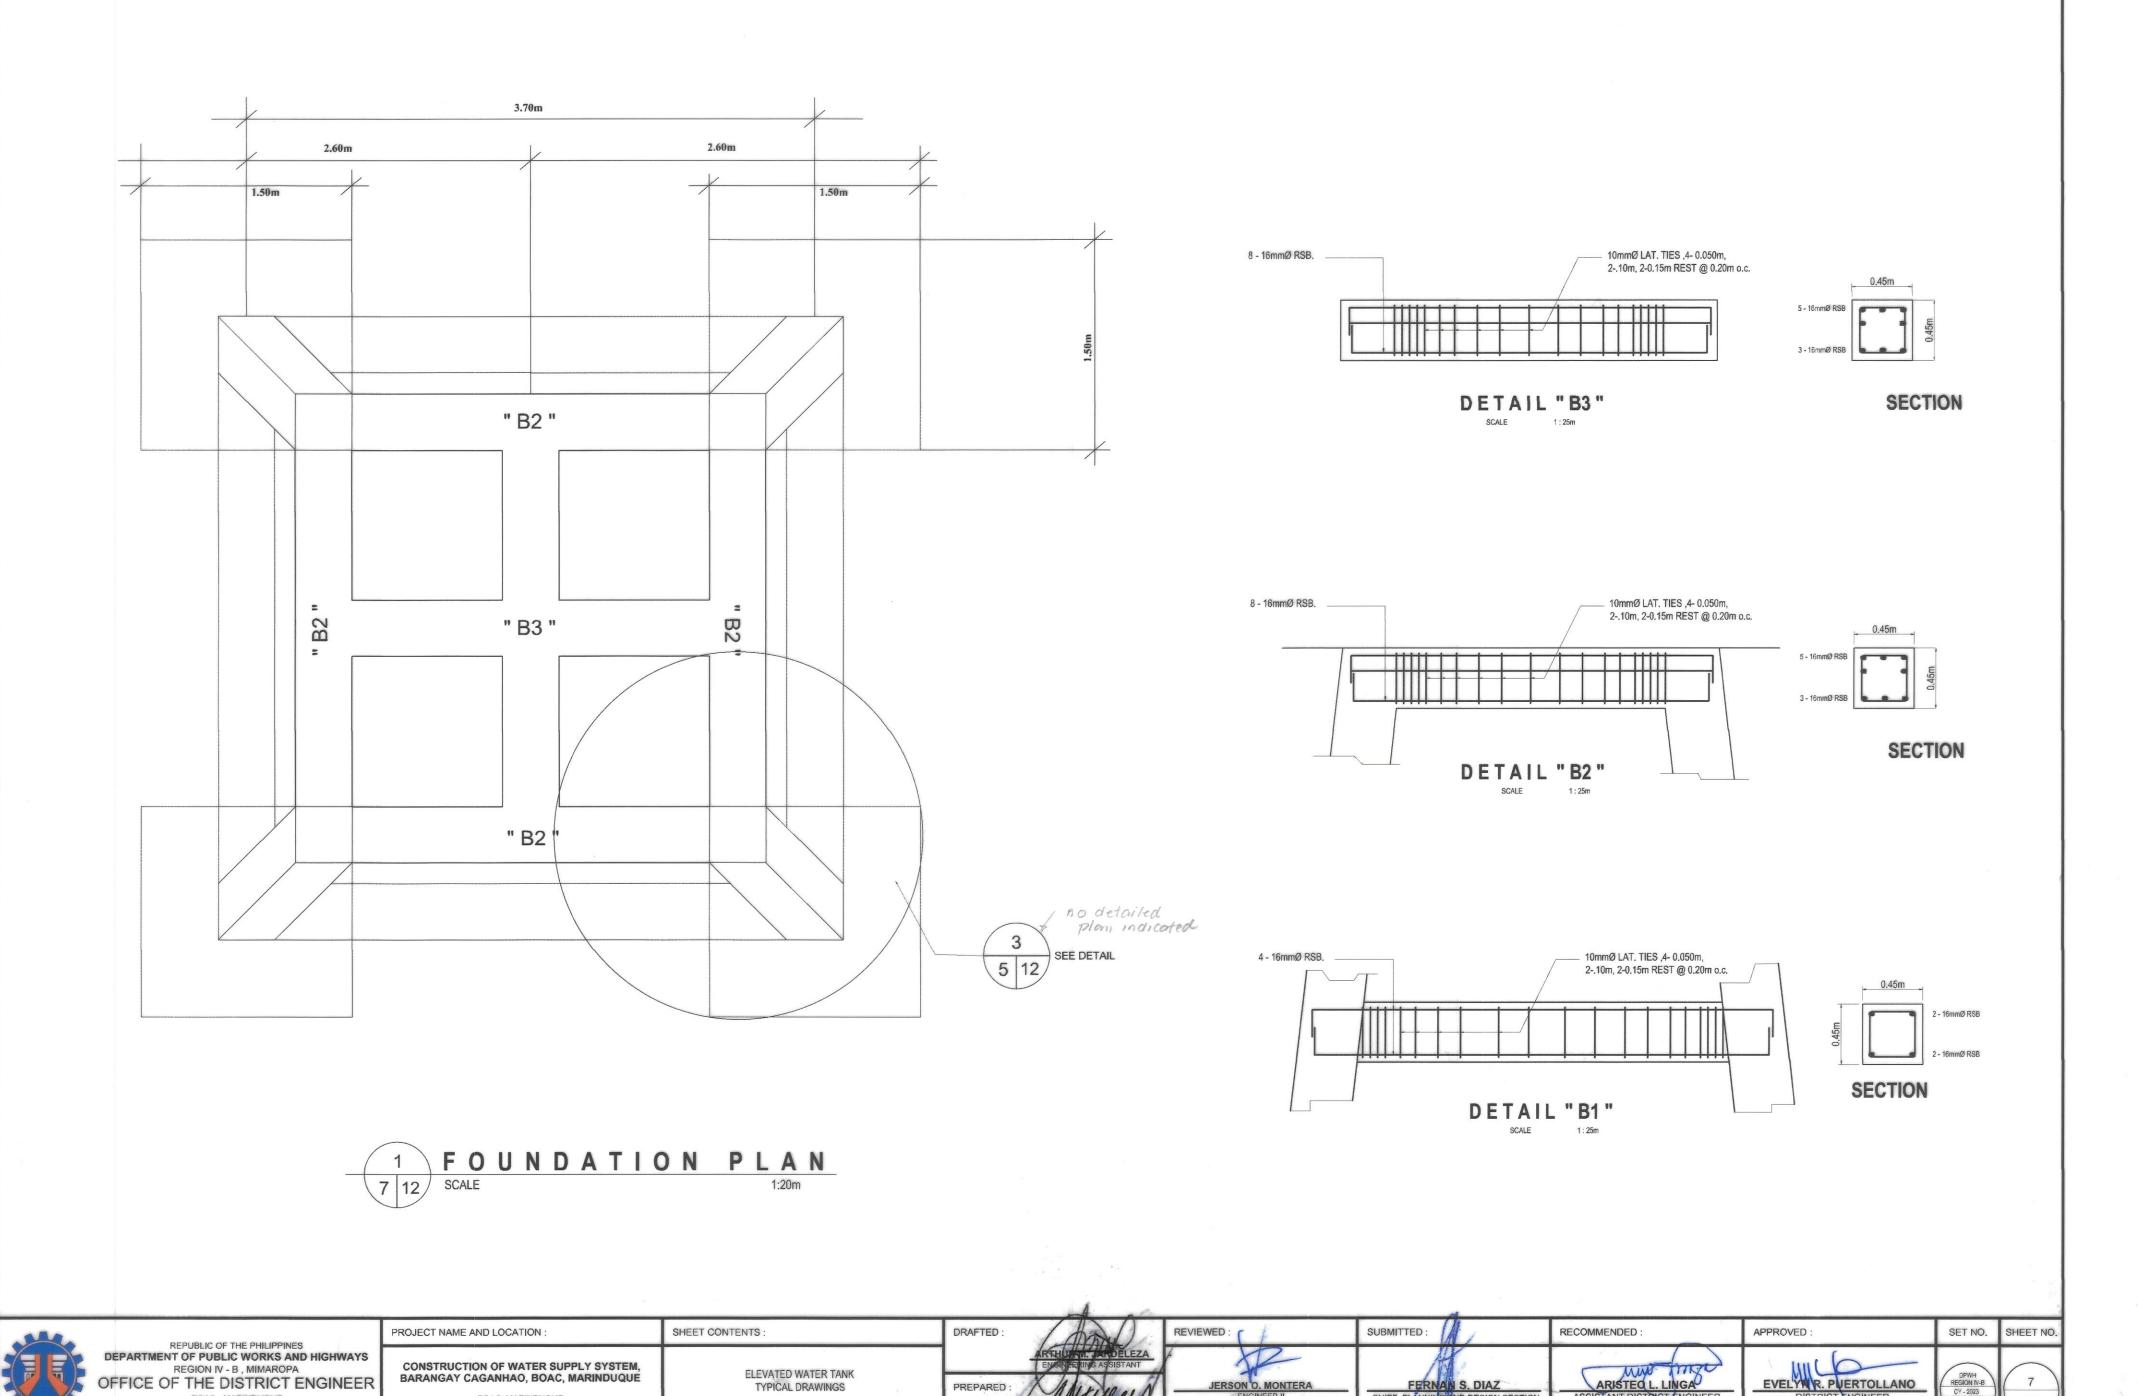

OFFICE OF THE DISTRICT ENGINEER BOAC, MARINDUQUE


BOAC, MARINDUQUE


FERNAN S. DIAZ


CHIEF, PLÂNNING AND DESIGN SECTION DATE:

DPWH REGION IV-B CY - 2023

EVELYN R. PUERTOLLANO
DISTRICT ENGINEER

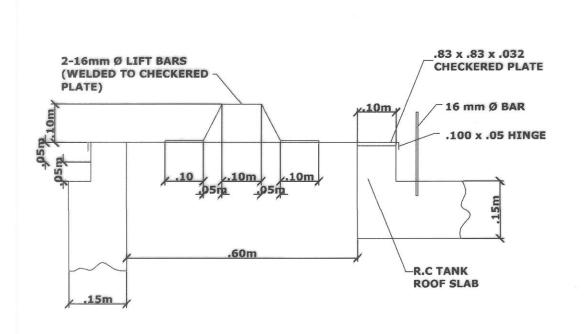

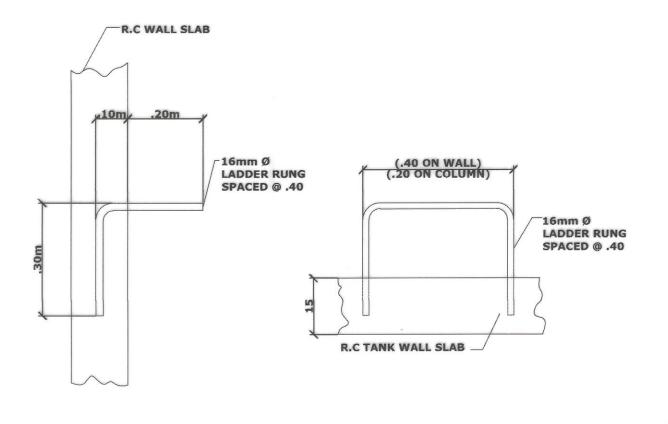


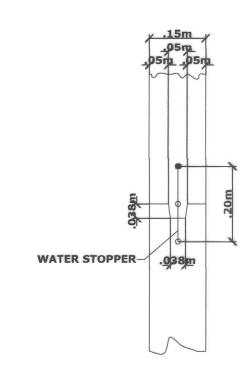





DETAIL OF LADDER RUNG

CONST. JOINT DETAIL

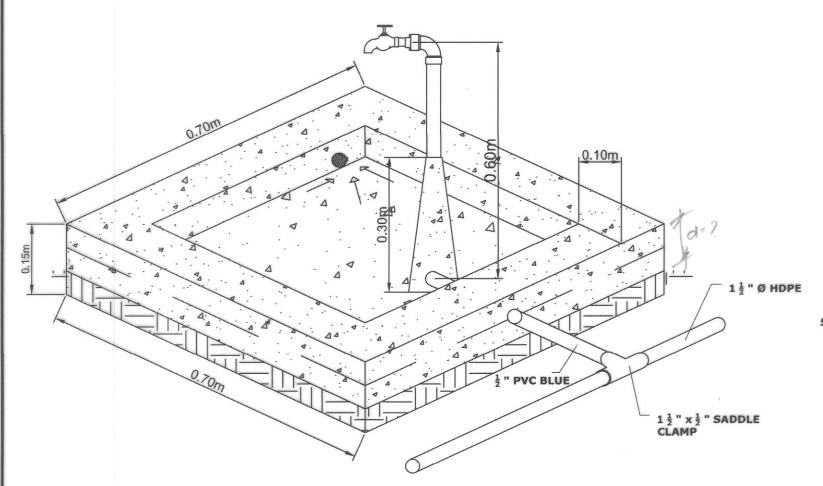

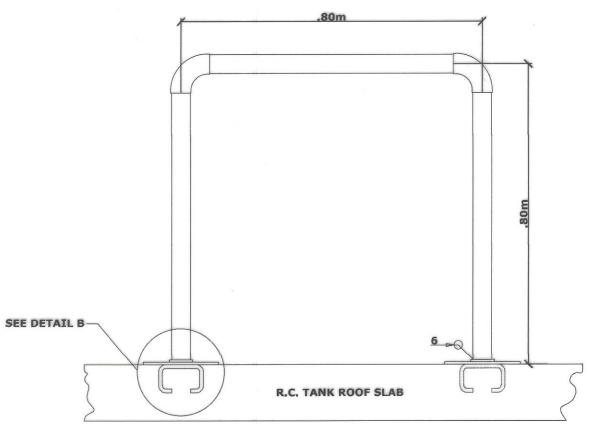

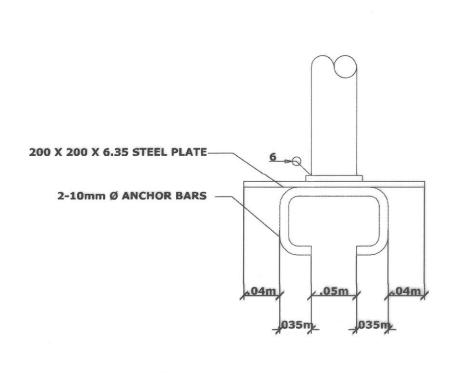


DETAIL OF COMMUNAL FAUCET

DETAIL OF STEEL PIPE RAILING


B

	REPUBLIC OF THE PHILIPPINES DEPARTMENT OF PUBLIC WORKS AND HIGHWAYS REGION IV - B , MIMAROPA OFFICE OF THE PHILIPPINES DEPARTMENT OF THE PHILIPPINES REPUBLIC OF THE PHILIPPINES REPUBLI
1	BOAC , MARINDUQUE

- 1	PROJECT NAME AND LOCATION:
s R	CONSTRUCTION OF WATER SUF BARANGAY CAGANHAO, BOAC,
	BOAC, MARINDUQUE
- 1	

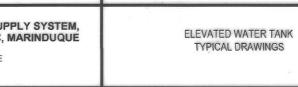

SHEET CONTENTS:

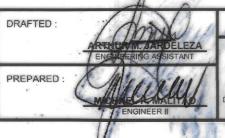

A	REVIEWED:	. 45
-	2	
	JERSON O. MONTERA	T.
	ENGINEER II	
	DATE :	


	SUBMITTED:	
-	FERN	IN S. DIAZ
100000000000000000000000000000000000000		AND DESIGN SECTION


RECOMMENDED:	
	Male
(Juliu)	18
ARISTEQ L.	
ASSISTANT DISTRI	CT ENGINEER
DATE:	


API	RUI	/ED					
E	VEL	W		THE THE	RTC) LL/	ANG
_		200000000000000000000000000000000000000	TRIC				
DATE	:						






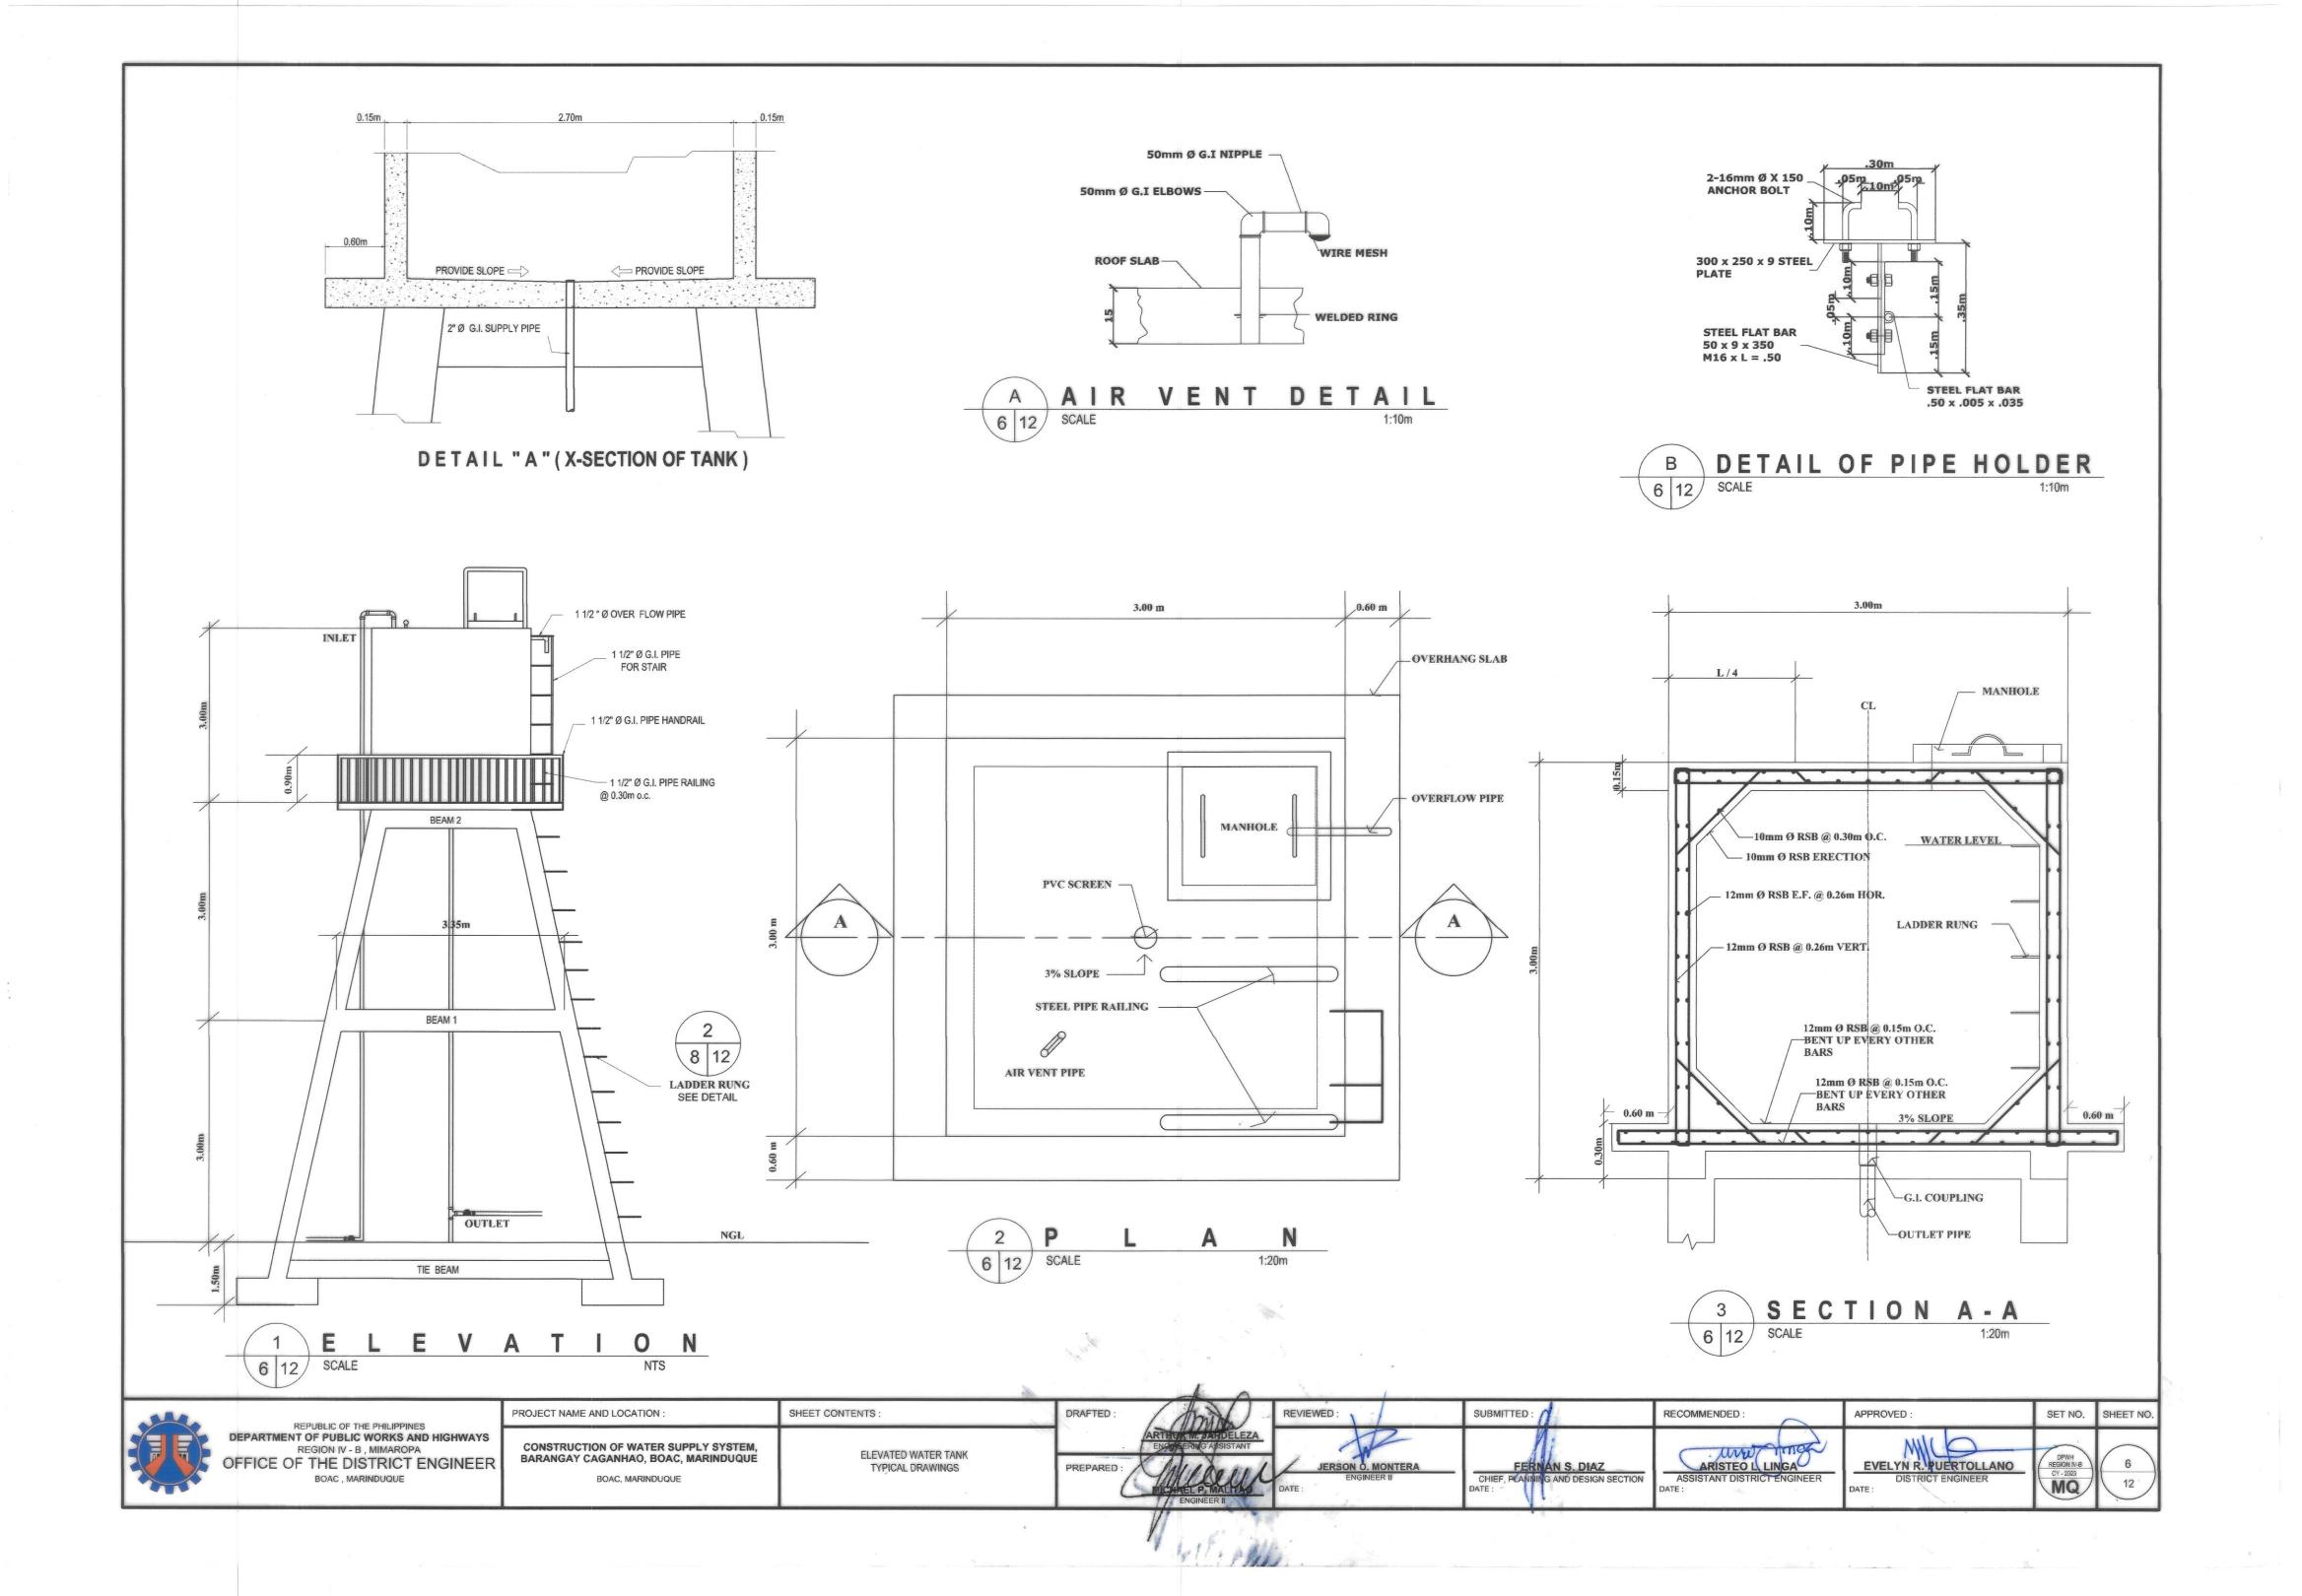

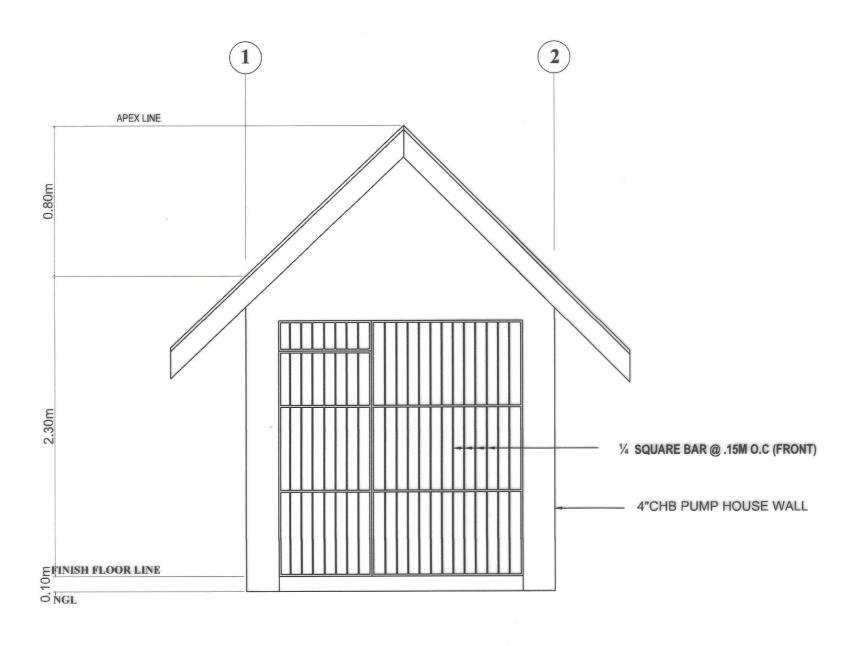

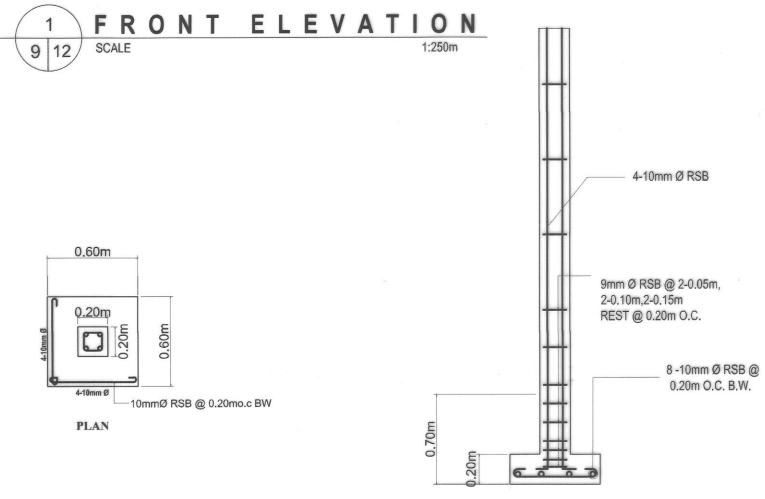

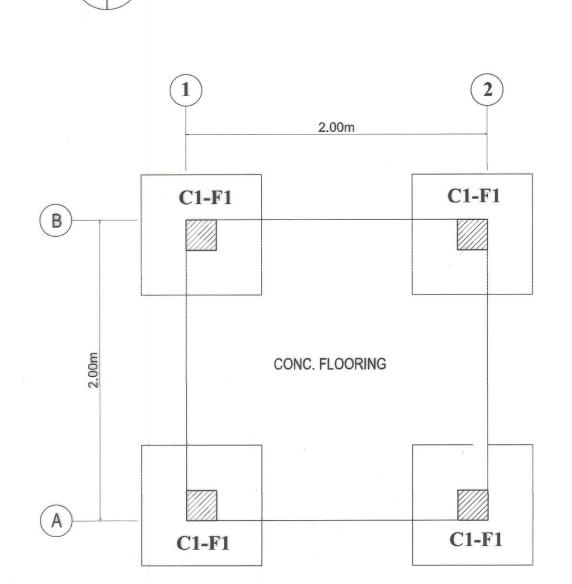

2.00m

PUMP HOUSE

P L A N

D-1

F L O O R

B

(A)

4 FOUNDATION PLAN
9 12 SCALE 1:250m

REPUBLIC OF THE PHILIPPINES DEPARTMENT OF PUBLIC WORKS AND HIGHW REGION IV - B , MIMAROPA OFFICE OF THE DISTRICT ENGINE BOAC , MARINDUQUE	
---	--

CT NAME AND LOCATION :	SHEET CONTENTS:
NSTRUCTION OF WATER SUPPLY SYSTEM, ANGAY CAGANHAO, BOAC, MARINDUQUE	PUMP HOUSE TYPICAL DRAWINGS

3 DETAIL OF C1-F1
9 12 SCALE 1:20m

C1-F1

PREPARED:

MICHAELIA


PREPARED:

	REVIEWED:
ELEZA	1
11/14	JERSON
ACHAD THE	DATE:
1 100	. 6

1	100	SUBMITTED:	
1	2	1	V
SON	D. MONTERA	FERNA	N S. DIA
ENG	INEER II	CHIEF, PLANNING DATE :	AND DESIG
	to Manager Transport	The state of the s	100

RECOMMENDED:		L
ARISTEO L. I ASSISTANT DISTRIC	INGA T ENGINEER	0

APPROVED :	SET NO.	SHEET NO.			
EVELYN R. PUERTOLLANO DISTRICT ENGINEER	DPWH REGION IV-B CY - 2023	9			

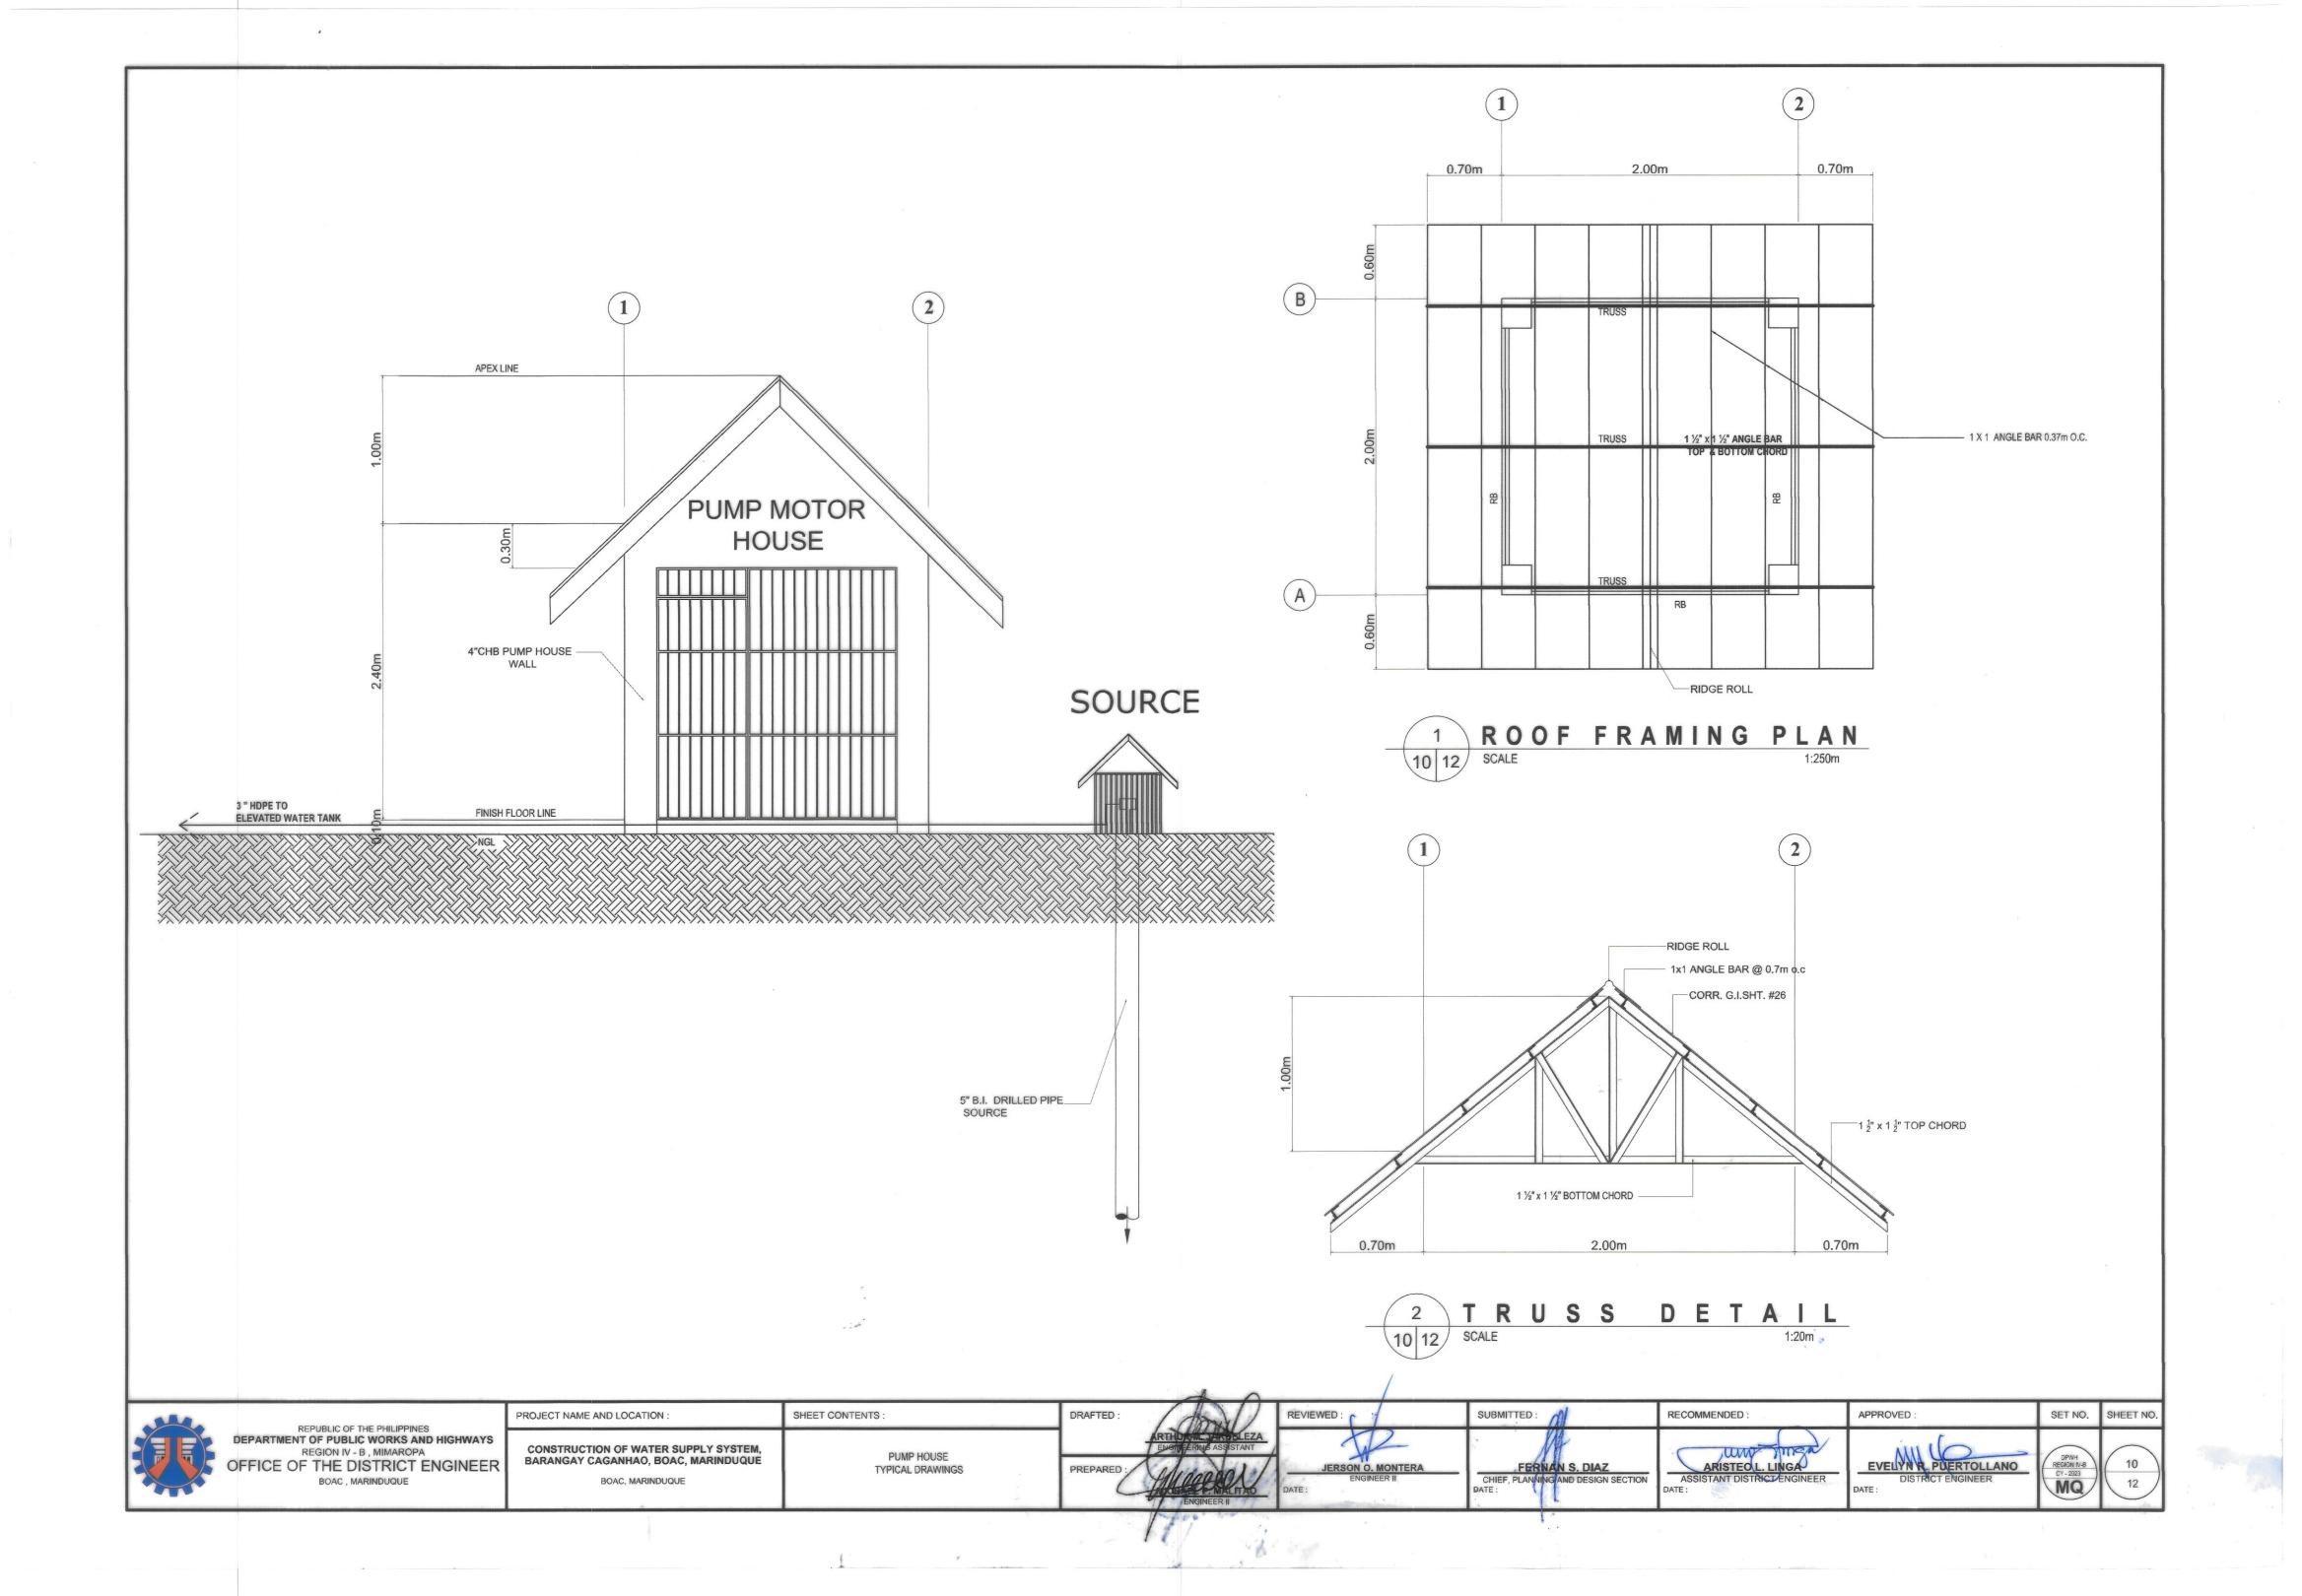

						S	CH	ΗE	Dι	JL	E	F	LO	A D	S				Toping		
CIRCUIT NUMBER	LOAD DESCRIPTION	НР	OUTLETS				SWITCHES				VOLT.	AMD	OCPD BOLT			LT-ON		CONDUCTORS	CONDUIT	AREA SERVED	
			O.L.	MOTOR	C.O.	L.O.	S	S2	S3	S3W	ABAD	AMP.	. VOLTS	AF	Р	AT	KAIC	THHN CU STRANDED	CONDOIT	AREA SERVED	
	LIGHTING POINTS AND CONVENIENCE OUTLET							1			380	1.652	230V	50	2	20	10	2 # 3.5 mm ² E= 1 # 2.0 mm ²	20 MMØ	COMMERCIAL BLDG. INSIDE	
2	WATER PUMP	ЗНР		1							3910	17.0	230V	50	2	40	10	2 # 5.5 mm ² E= 1 # 3.5 mm ²	20 MMØ	COMMERCIAL BLDG. INSIDE	
3	SPARE										1500	6.26	230V	50	2	20	10			SPARE	
4	SPARE										1500	6.26	230V	50	2	20	10			SPARE	
	TOTAL										7290										
MAXIMUM DEMAND IN 7,290				290	0						.C.P.D						SERVICE ENTRANCE CONDUCTOR: 2 # 14MM² THHN WIRE				
MAXIMUM DEMAND IN 57.19				BREAKER			Q	QTY.		E AT	AF	Р		KAI	C G	GROUNDING CONDUCTOR:					
			57	57.19 MAI		MAIN	N 1		МССВ	B 60	100	2		10		1 # 8.0MM ² TW WIRE					
					BRANCI		HES 1		1	MCE	3 40	50	2		10	M	IAIN	CONDUIT:			
						(•		3	MCE	3 20	50	2		10				25MMØ RSC CONDUIT		

COMPUTATONS FOR MAIN SERVICE ENTRANCE CONDUCTOR

I= 7,290VA + (3910VA x 0.25)

= 35.94A

USE 2NOS. 14.0mm² THHN WIRE 1NO. 8.0mm² TW WIRE (G) IN 1Ø 25mm²

COMPUTATONS

FOR MAIN DISCONNECTION EQUIPMENT


I₇ 7,290VA + (3910VA x 1.50)

230V = 57.19A


USE ONE 60AT, 100AF,2P, 230V, MCCB WITH GROUND BUS AND BRANCHES: 1NO-40AT, 50AF, 2P


LEGEND:



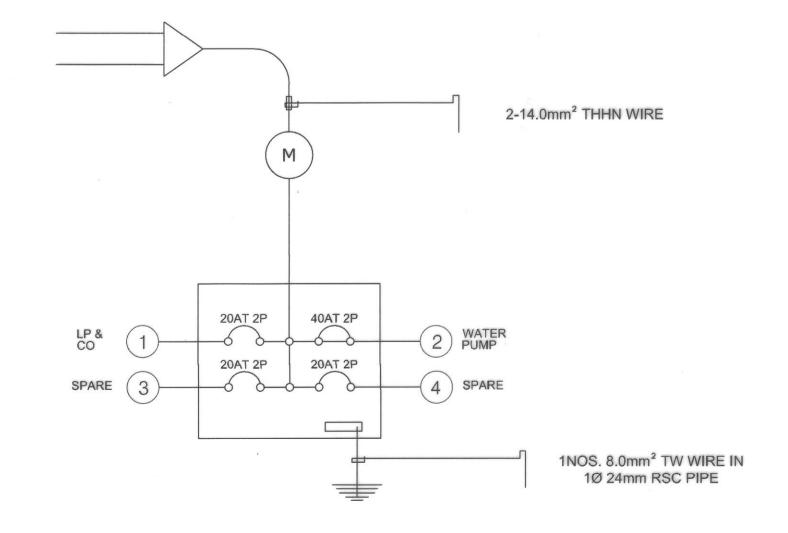



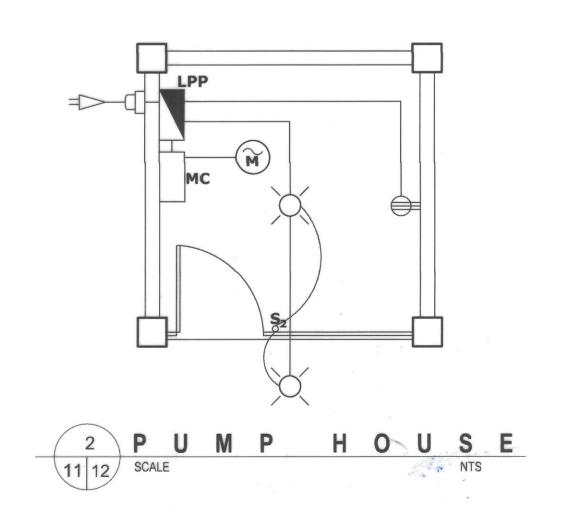

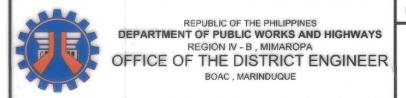

PROJECT NAME AND LOCATION: CONSTRUCTION OF WATER SUPPLY SYSTEM, BARANGAY CAGANHAO, BOAC, MARINDUQUE BOAC, MARINDUQUE

SCHEDULE OF LOADS - PUMP HOUSE **ELECTRICAL - PUMP HOUSE** TYPICAL DRAWING

SHEET CONTENTS:

DRAFTED: PREPARED:

REVIEWED

CHIEF, PLANNING AND DESIGN SECTION DATE:

SUBMITTED:


RECOMMENDED: ARISTEO L LINGA
ASSISTANT DISTRICT ENGINEER

EVEL PUERTOLLANO
DISTRICT ENGINEER

APPROVED :

DPWH REGION IV-B CY - 2023

SET NO. SHEET NO.

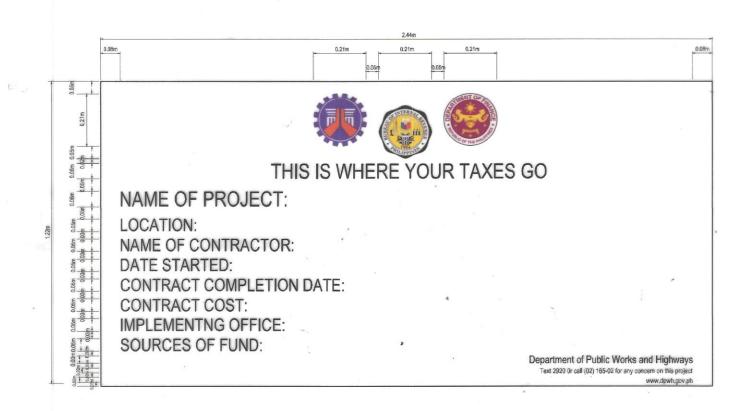




DETAIL OF BILLBOARD


NOTES:


1. THE INSTALLATION OF THE REQUIRED STANDARD BILLBOARD SIZE (1200MM X 2400MM / 4 FT. X 8FT.) FOR ALL PROJECTS SHALL BE STRICTLY ENFORCED.

2. NO POLITICAL BILLBOARDS SHALL BE ALLOWED TO BE INSTALLED 100 METERS BEFORE AND 100 METERS AFTER ALL DPWH PROJECTS AND IN BETWEEN THE PROJECT LIMITS OR WITHIN THE ROAD RIGHT OF WAY.

3. DPWH CONTRACTORS SHALL NOT BE ALLOWED TO PLACE NAMES OF POLITICIANS ON THEIR EQUIPMENT OR CARRY POLITICAL BILLBOARD ON THEIR EQUIPMENT.

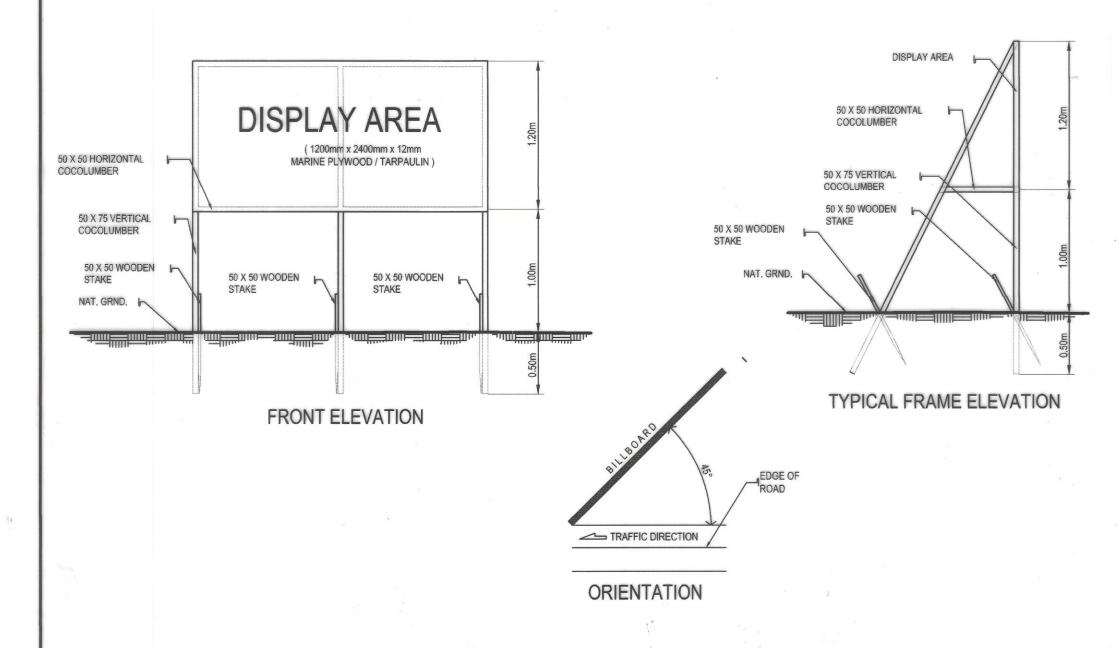


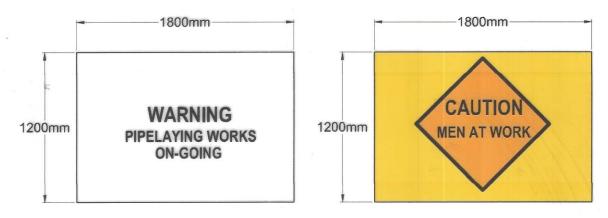

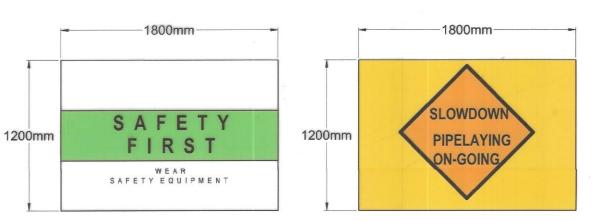





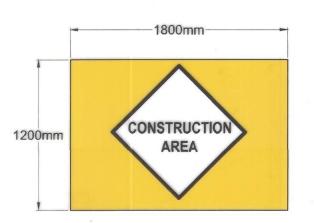


2

12 12



WATERWORKS CONSTRUCTION SIGNAGE


NOTE: SIGNS SHALL BE MADE FROM RETROFLECTIVE SIGN FACE MATERIAL AS PER DO 13 SERIES OF 2018

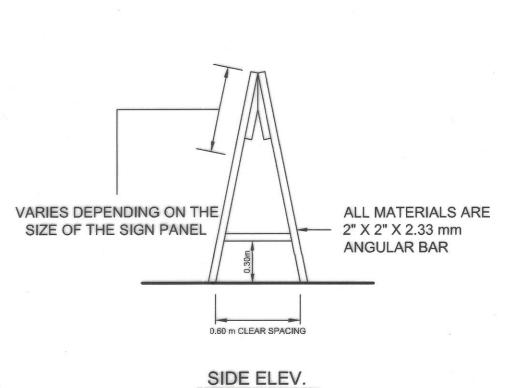

APPROPRIATE SHEETING FASTENED WITH BOLTS AND NUTS FOR EASE OF REPLACEMENT SLOWDOW **PIPELAYING** ON-GOING ALL MATERIALS ARE VARIES DEPENDING ON THE

FRONT ELEVATION

SIGNAGE INSTALLATION DETAIL

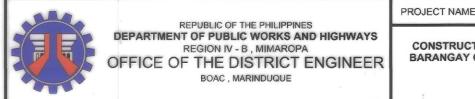

SHEET CONTENTS: PROJECT NAME AND LOCATION: DRAFTED: CONSTRUCTION OF WATER SUPPLY SYSTEM, BARANGAY CAGANHAO, BOAC, MARINDUQUE TYPICAL DRAWINGS PREPARED: BOAC, MARINDUQUE

SUBMITTED: FERNAN S. DIAZ
CHIEF, PLANNING AND DESIGN SECTION RECOMMENDED:

APPROVED

SET NO.

12

SHEET NO.