

REPUBLIC OF THE PHILIPPINES

DEPARTMENT OF PUBLIC WORKS AND HIGHWAYS

REGION IV-B, MIMAROPA
OFFICE OF THE DISTRICT ENGINEER
BOAC, MARINDUQUE

C.Y. 2023 PROJECT


DETAILED ENGINEERING DESIGN PLAN FOR CONSTRUCTION OF SOLAR WATER SYSTEM, TORRIJOS, MARINDUQUE


BRGY. TIGWI, TORRIJOS, MARINDUQUE

SUBMITTED:	RECOMMENDED:	APPROVED:
Mz /		
FERNAN S. DIAZ	VACANT	EVELYN R. PUERTOLLANO
CHIEF, PLANNING AND DESIGN SECTION	VAOAITI	DISTRICT ENGINEER
DATE:	DATE:	DATE:

	INDEX OF SHE	E T
CATEGORY	DESCRIPTION	SHEET NO.
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GENERAL	LOCATION PLAN	3 - 4
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		TYPICAL DRAWING:	3		5 - 10
		SUMMA	ARY OF QUA	NTITIES	
ITEM NO.		DESCRIPTION	ORIGINAL QUANTITY	UNIT	REMARKS
PART I:	FACILITIES FOR THE ENGINE	EER			
A.1.1(8)	PROVISION OF	FIELD OFFICE FOR THE ENGINEER (RENTAL BASIS)	4.00	mos.	
PART II:	OTHER GENERAL REQUIRE	MENTS			
A.1.2(4)	PROVISION OF FIELD 4x2 PICK U	P TYPE SERVICE VEHICLE FOR THE ENGINEER ON BARE RENTAL BASIS	4,00	mos.	
B.4(10)	N	MISCELLANEOUS SURVEY AND STAKING	1.00	LS	Staked Plan To be submitted by the contractor
B.5		PROJECT BILLBOARD / SIGNBOARD	1.00	each	DPWH Standard Billboard
B.7(2)	OCCL	JPATIONAL SAFETY AND HEALTH PROGRAM	1.00	LS	Includes Personal Protective Equipment (PPE), Safety Signages and Health Program
B.9		MOBILIZATION / DEMOBILIZATION	1.00	LS	
PART A:	EARTHWORKS				
803(1)a	ST	RUCTURE EXCAVATION (COMMON SOIL)	18.83	m³	For Foundation and Pipelines
804(4)		GRAVEL FILL	1.63	m³	For Concrete Foundation
PART B:	PLAIN AND REINFORCED CO	ONCRETE WORKS			
900(1)c2	STRUCTURAL CONC	RETE FOR FOOTING AND SLAB ON FILL (CLASS A, 28 DAYS)	17.37	m³	For Chlorinator House & Perimeter Fence
902(1)a	REII	NFORCING STEEL (DEFORMED), GRADE 40	1,419.17	kgs	For Chlorinator House & Perimeter Fence
902(1)b	REII	NFORCING STEEL (DEFORMED), GRADE 60	485.63	kgs	For Chlorinator House & Perimeter Fence
903(2)		FORMWORKS AND FALSEWORKS	84.46	m ²	For Chlorinator House & Perimeter Fence
PART C:	FINISHING WORKS				
1027(1)		CEMENT PLASTER FINISH	164.35	m ²	For Chlorinator House & Perimeter Fence
1046(2)a1	100MM CHB NO	ON-LOAD BEARING (INCLUDING REINFORCING STEEL)	91.02	m ²	For Chlorinator House & Perimeter Fence
1032(1)a	P/	AINTING WORKS (MASONRY CONCRETE)	84.69	m ²	For Chlorinator House & Perimeter Fence
1032(1)b		PAINTING WORKS (WOOD)	5.88	m ²	For Chlorinator House & Perimeter Fence
1032(1)c		PAINTING WORKS (STEEL)	64.00	m ²	For Chlorinator House & Perimeter Fence
1004(2)		FINISHING HARDWARE	1,00	LS	For Chlorinator House & Perimeter Fence
1010(4)		WOODEN DOORS AND WINDOWS	1,00	LS	For Chlorinator House
1016(1)a		WATERPROOFING, CEMENT-BASE	8.45	m ²	For Chlorinator House
1018(1)		GLAZED TILES AND TRIMS	19.18	m ²	For Chlorinator House
1047(1)		STRUCTURAL STEEL	1.00	LS	For Perimeter Fence
PART D:	PLUMBING WORKS				
1001(8)		SEWER LINE WORKS	1.00	LS	For Chlorinator House
1001(9)		STORM DRAINAGE AND DOWNSPOUT	1.00	LS	For Chlorinator House
1001(10)		PIPES WITH FITTINGS CONNECTION	1.00	LS	For Distribution Line
1002(4)		PLUMBING FIXTURES	1.00	LS	For Chlorinator House
PART F:	ELECTRICAL WORKS				
1100(10)	CONDUIT, BOXES	, AND FITTINGS (CONDUIT WORKS/CONDUIT ROUGH-IN)	1.00	LS	For Chlorinator House
1101(33)	WIRES AND WIRING DEVICES		1.00	LS	For Chlorinator House
1102(1)	PANEL BOARD WITH MAIN & BRANCHES BREAKERS		1.00	LS	For Chlorinator House
1103(1)	LIGHTING FIXTURES AND LAMPS		1.00	LS	For Chlorinator House
1102(16)a1		GENERATOR SINGLE PHASE STAND BY	1.00	LS	
1102(18)	SOLAR PANE	L WITH INVERTER, BATTERY AND OTHER DEVICES	1.00	LS	
624(8)		SOLAR LED STREET LIGHT	4.00	each	



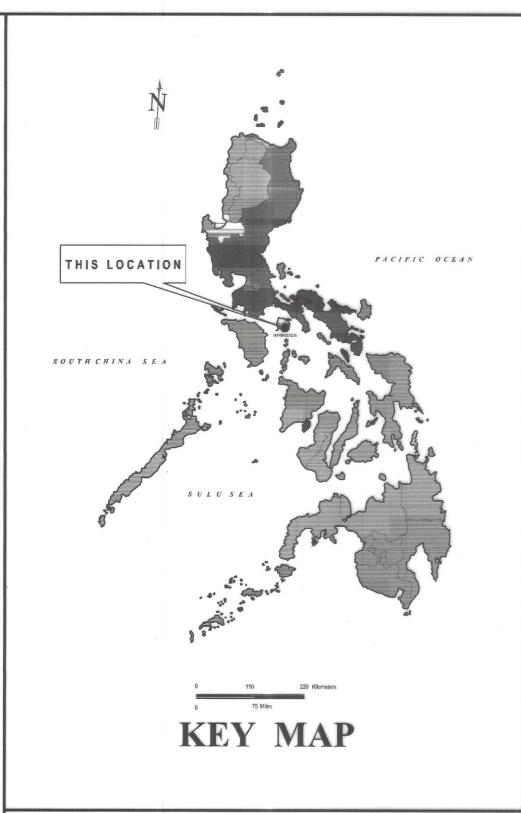

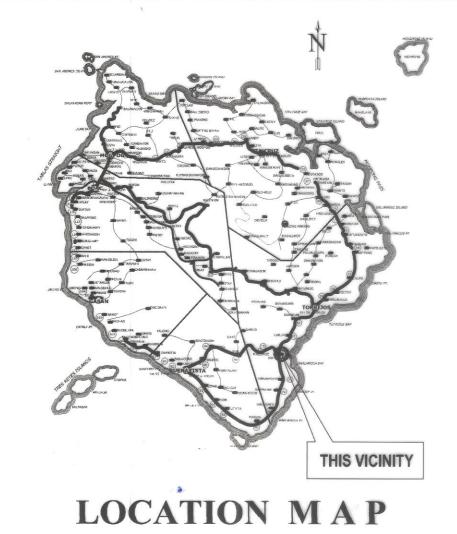REPUBLIC OF THE PHILIPPINES DEPARTMENT OF PUBLIC WORKS AND HIGHWAYS REGION IV - B , MIMAROPA OFFICE OF THE DISTRICT ENGINEE BOAC , MARINDUQUE

PROJECT NAME AND LOCATION:

CONSTRUCTION OF
SOLAR WATER SYSTEM, TORRIJOS, MARINDUQUE

BRGY. TIGWI, TORRIJOS, MARINDUQUE

SUMM

INDEX OF SHEETS SUMMARY OF QUANTITIES KEY MAP LOCATION MAP PREPARED:

MICHAELT MALITAGE ENGINEER II

JERSON O. MONTE

SUBMITTED:

FERNAN S. DIAZ
HIEF, PLANNING AND DESIGN SECTION
DA


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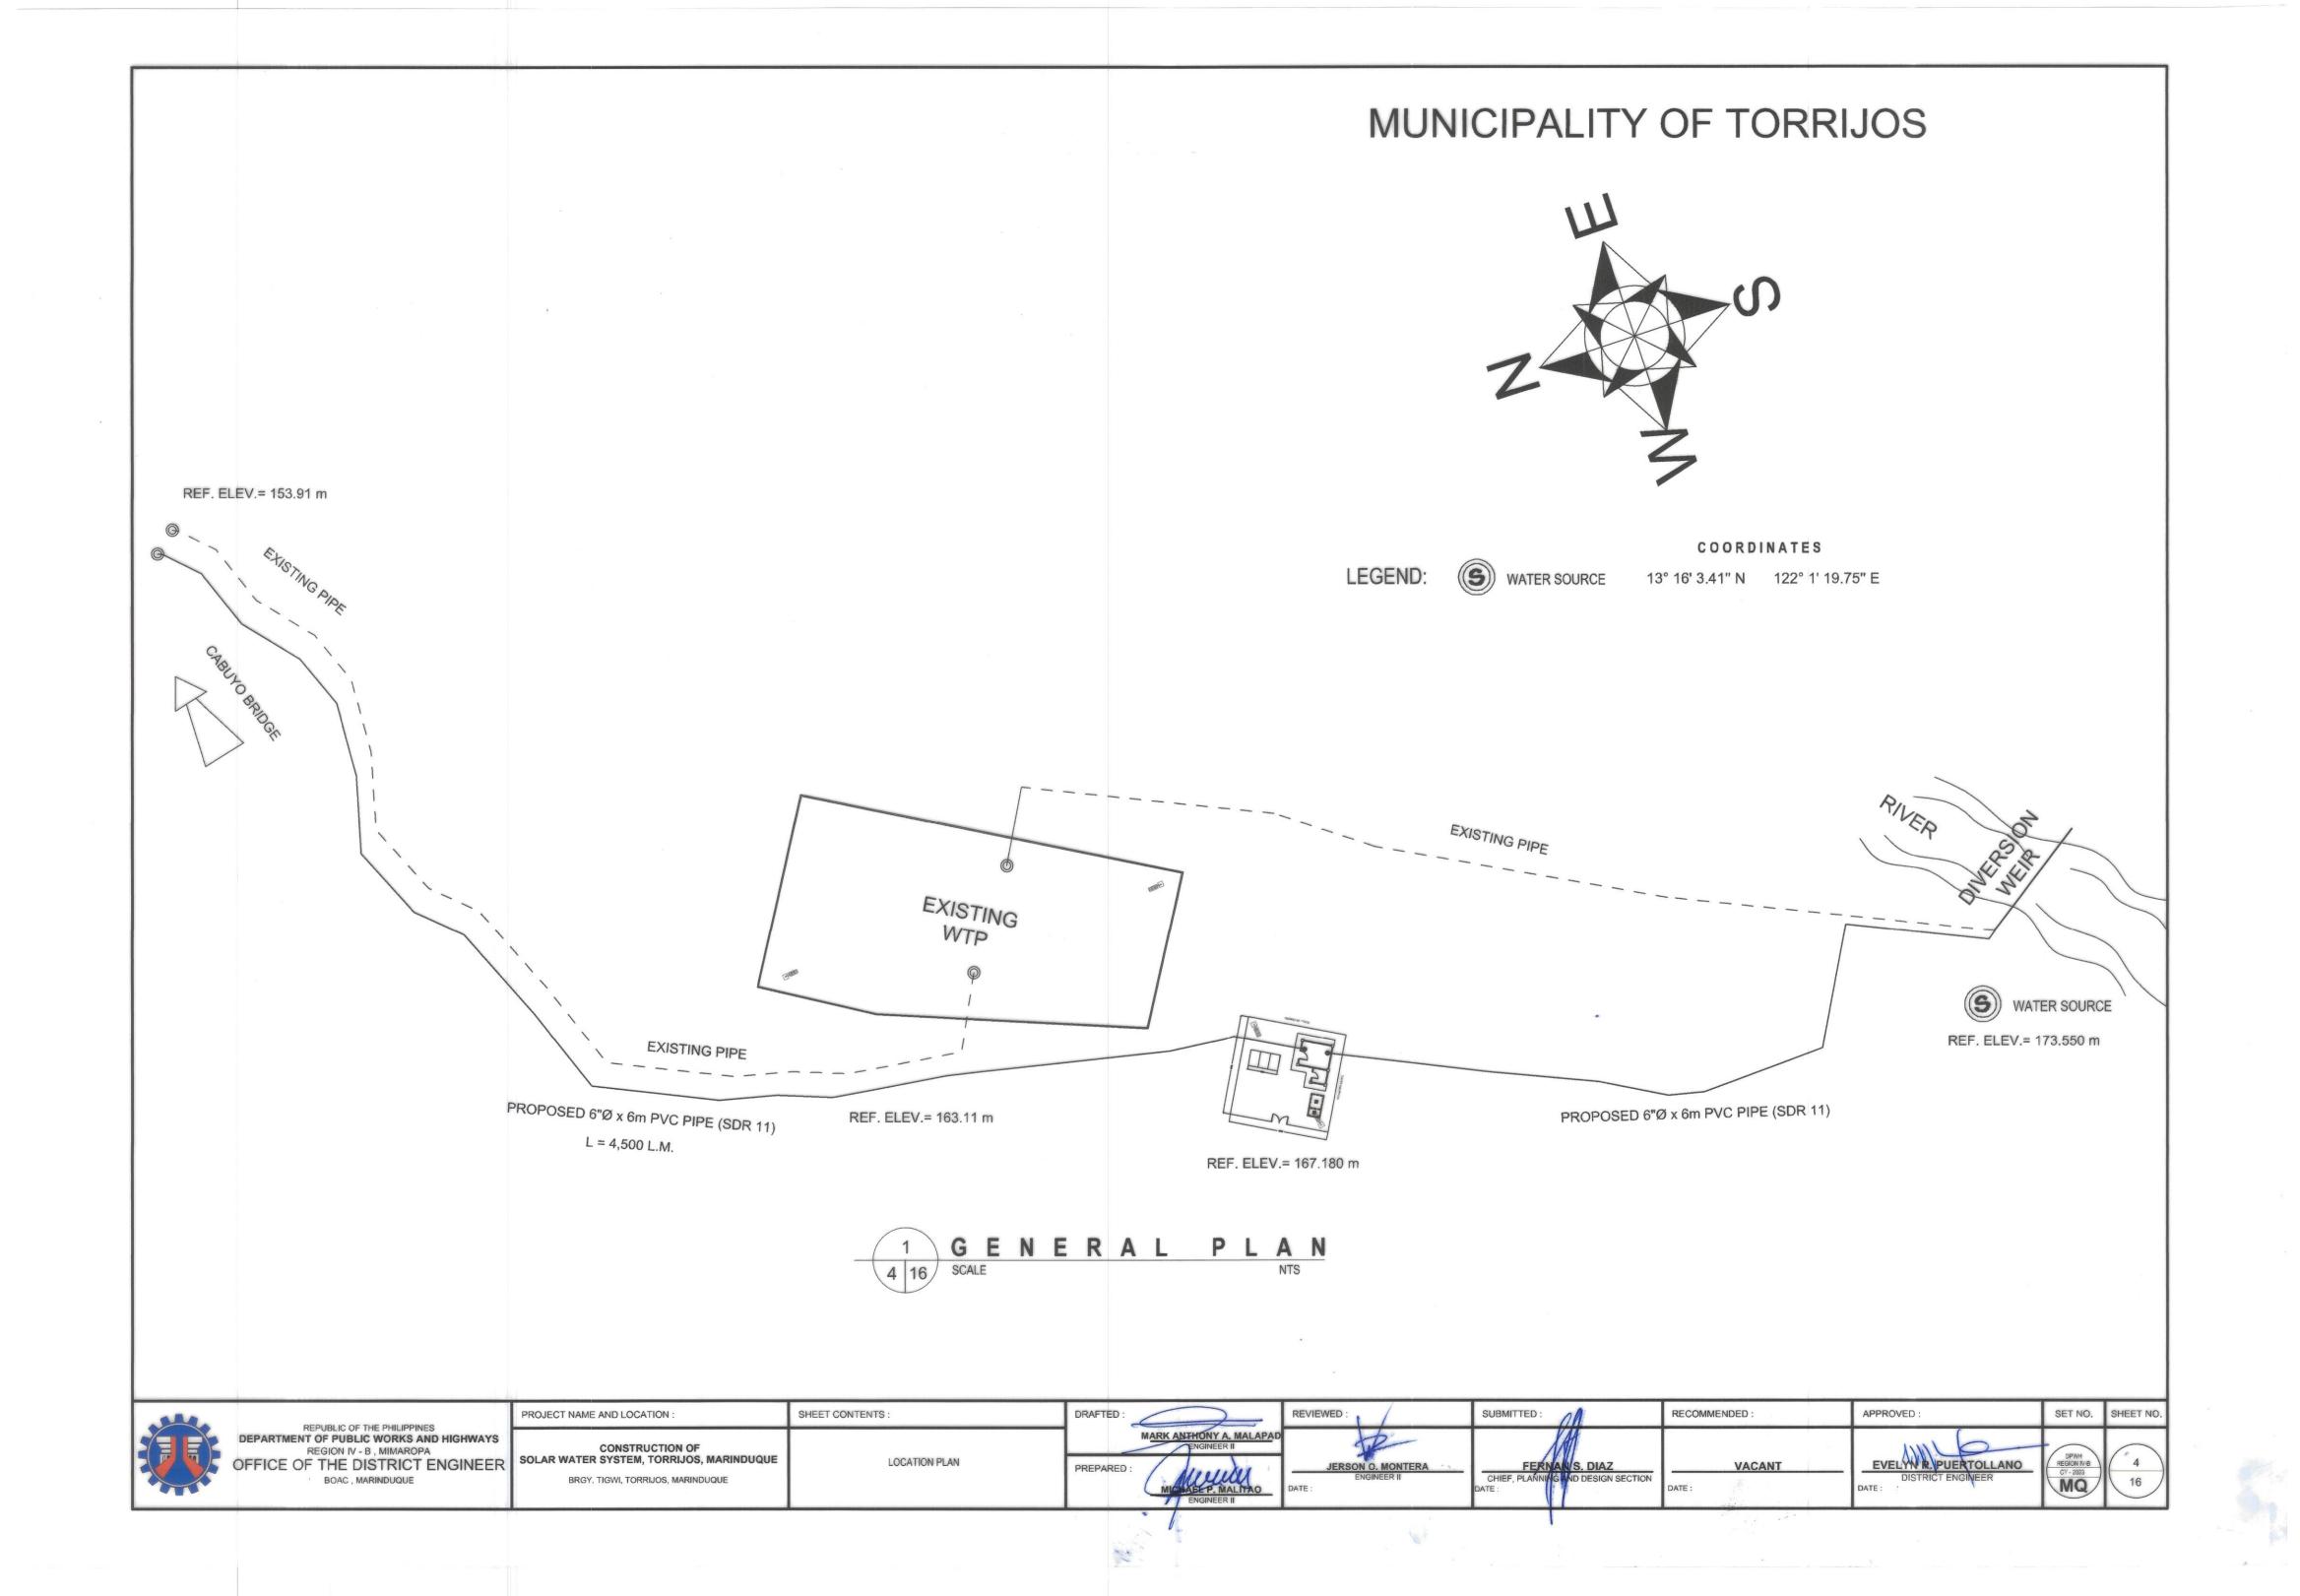
APPROVED :

TOLLANO NEER




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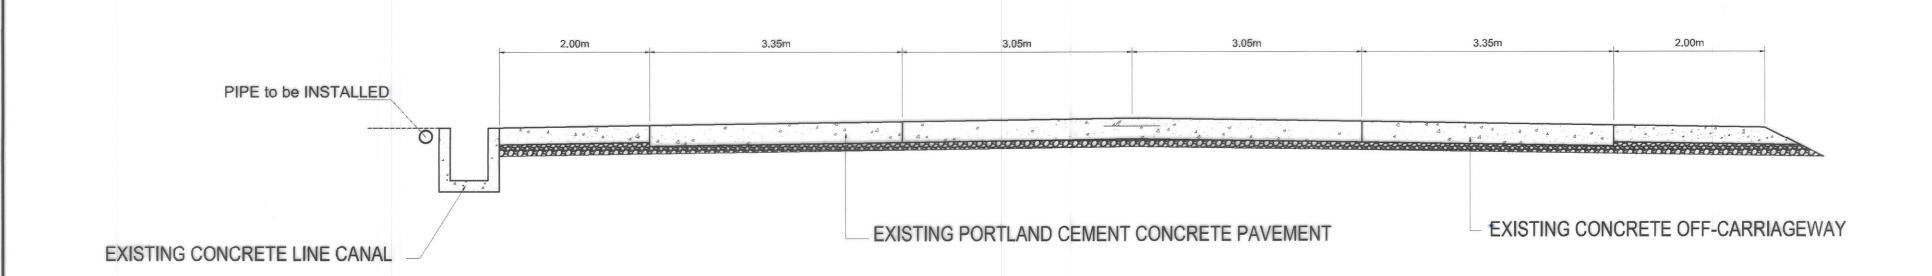


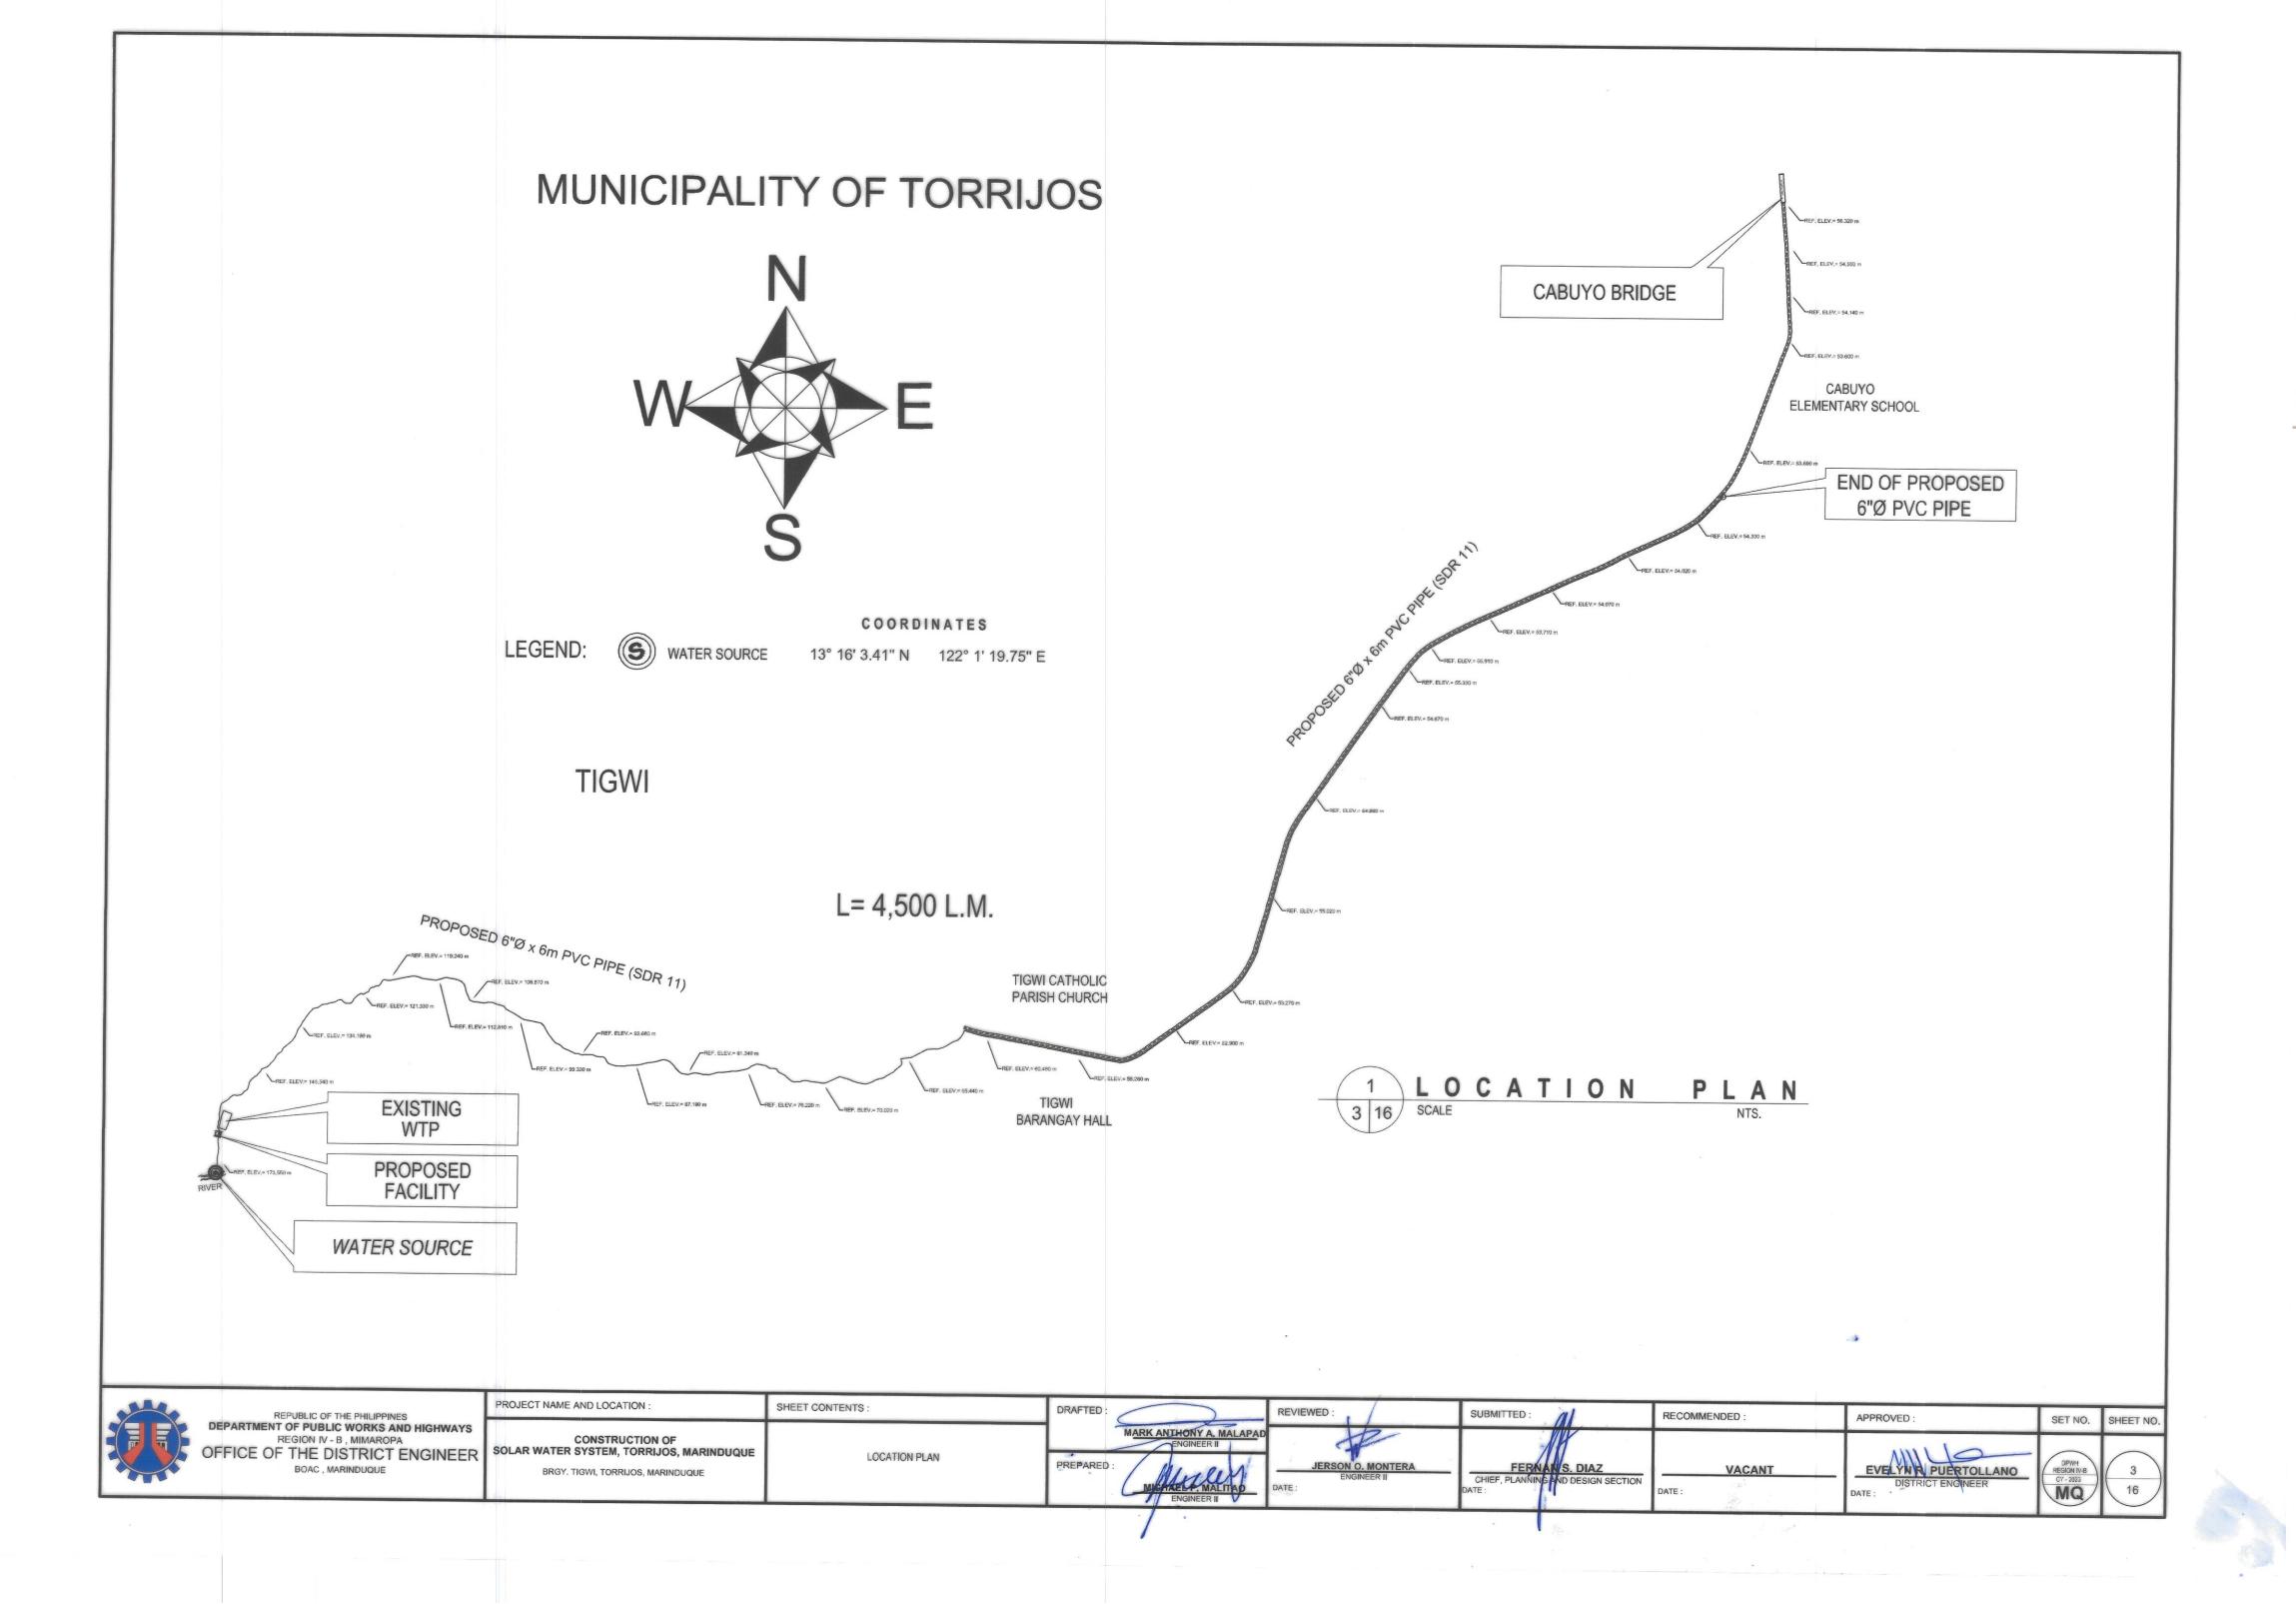

TYPICAL ROADWAY SECTION


SECTION THRU FARM TO MARKET ROAD




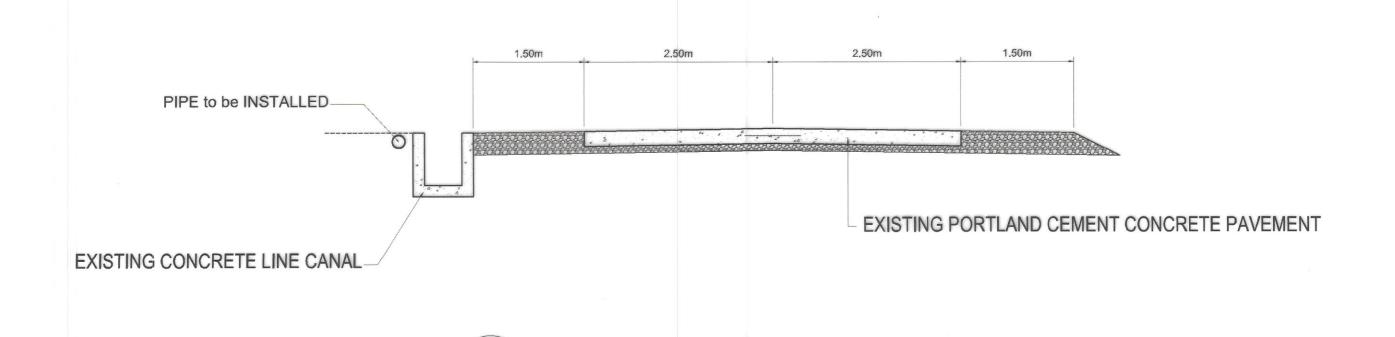

2 SECTION THRU NATIONAL ROAD
5 16 SCALE 1:50m

4844	REPUBLIC OF THE PHILIPPINES	PROJECT NAME AND LOCATION :	SHEET CONTENTS:	DRAFTED:	REVIEWED:	SUBMITTED:	RECOMMENDED:	APPROVED :	SET NO.	SHEET NO.
	DEPARTMENT OF PUBLIC WORKS AND HIGHWAYS	CONSTRUCTION OF SOLAR WATER SYSTEM, TORRIJOS, MARINDUQUE BRGY. TIGWI, TORRIJOS, MARINDUQUE	TYPICAL DRAWINGS	PREPARED: MICHAELP, MALITAD ENGINEER II	JERSON O. MONTERA ENGINEER II	FERNANS. DIAZ CHIEF, PLAÑNING AND DESIGN SECTION DATE:	VACANT	EVELYN R. PUERTOLLANO DISTRICT ENGINEER DATE:	DPWH REGION IV-B CY - 2023	5 16

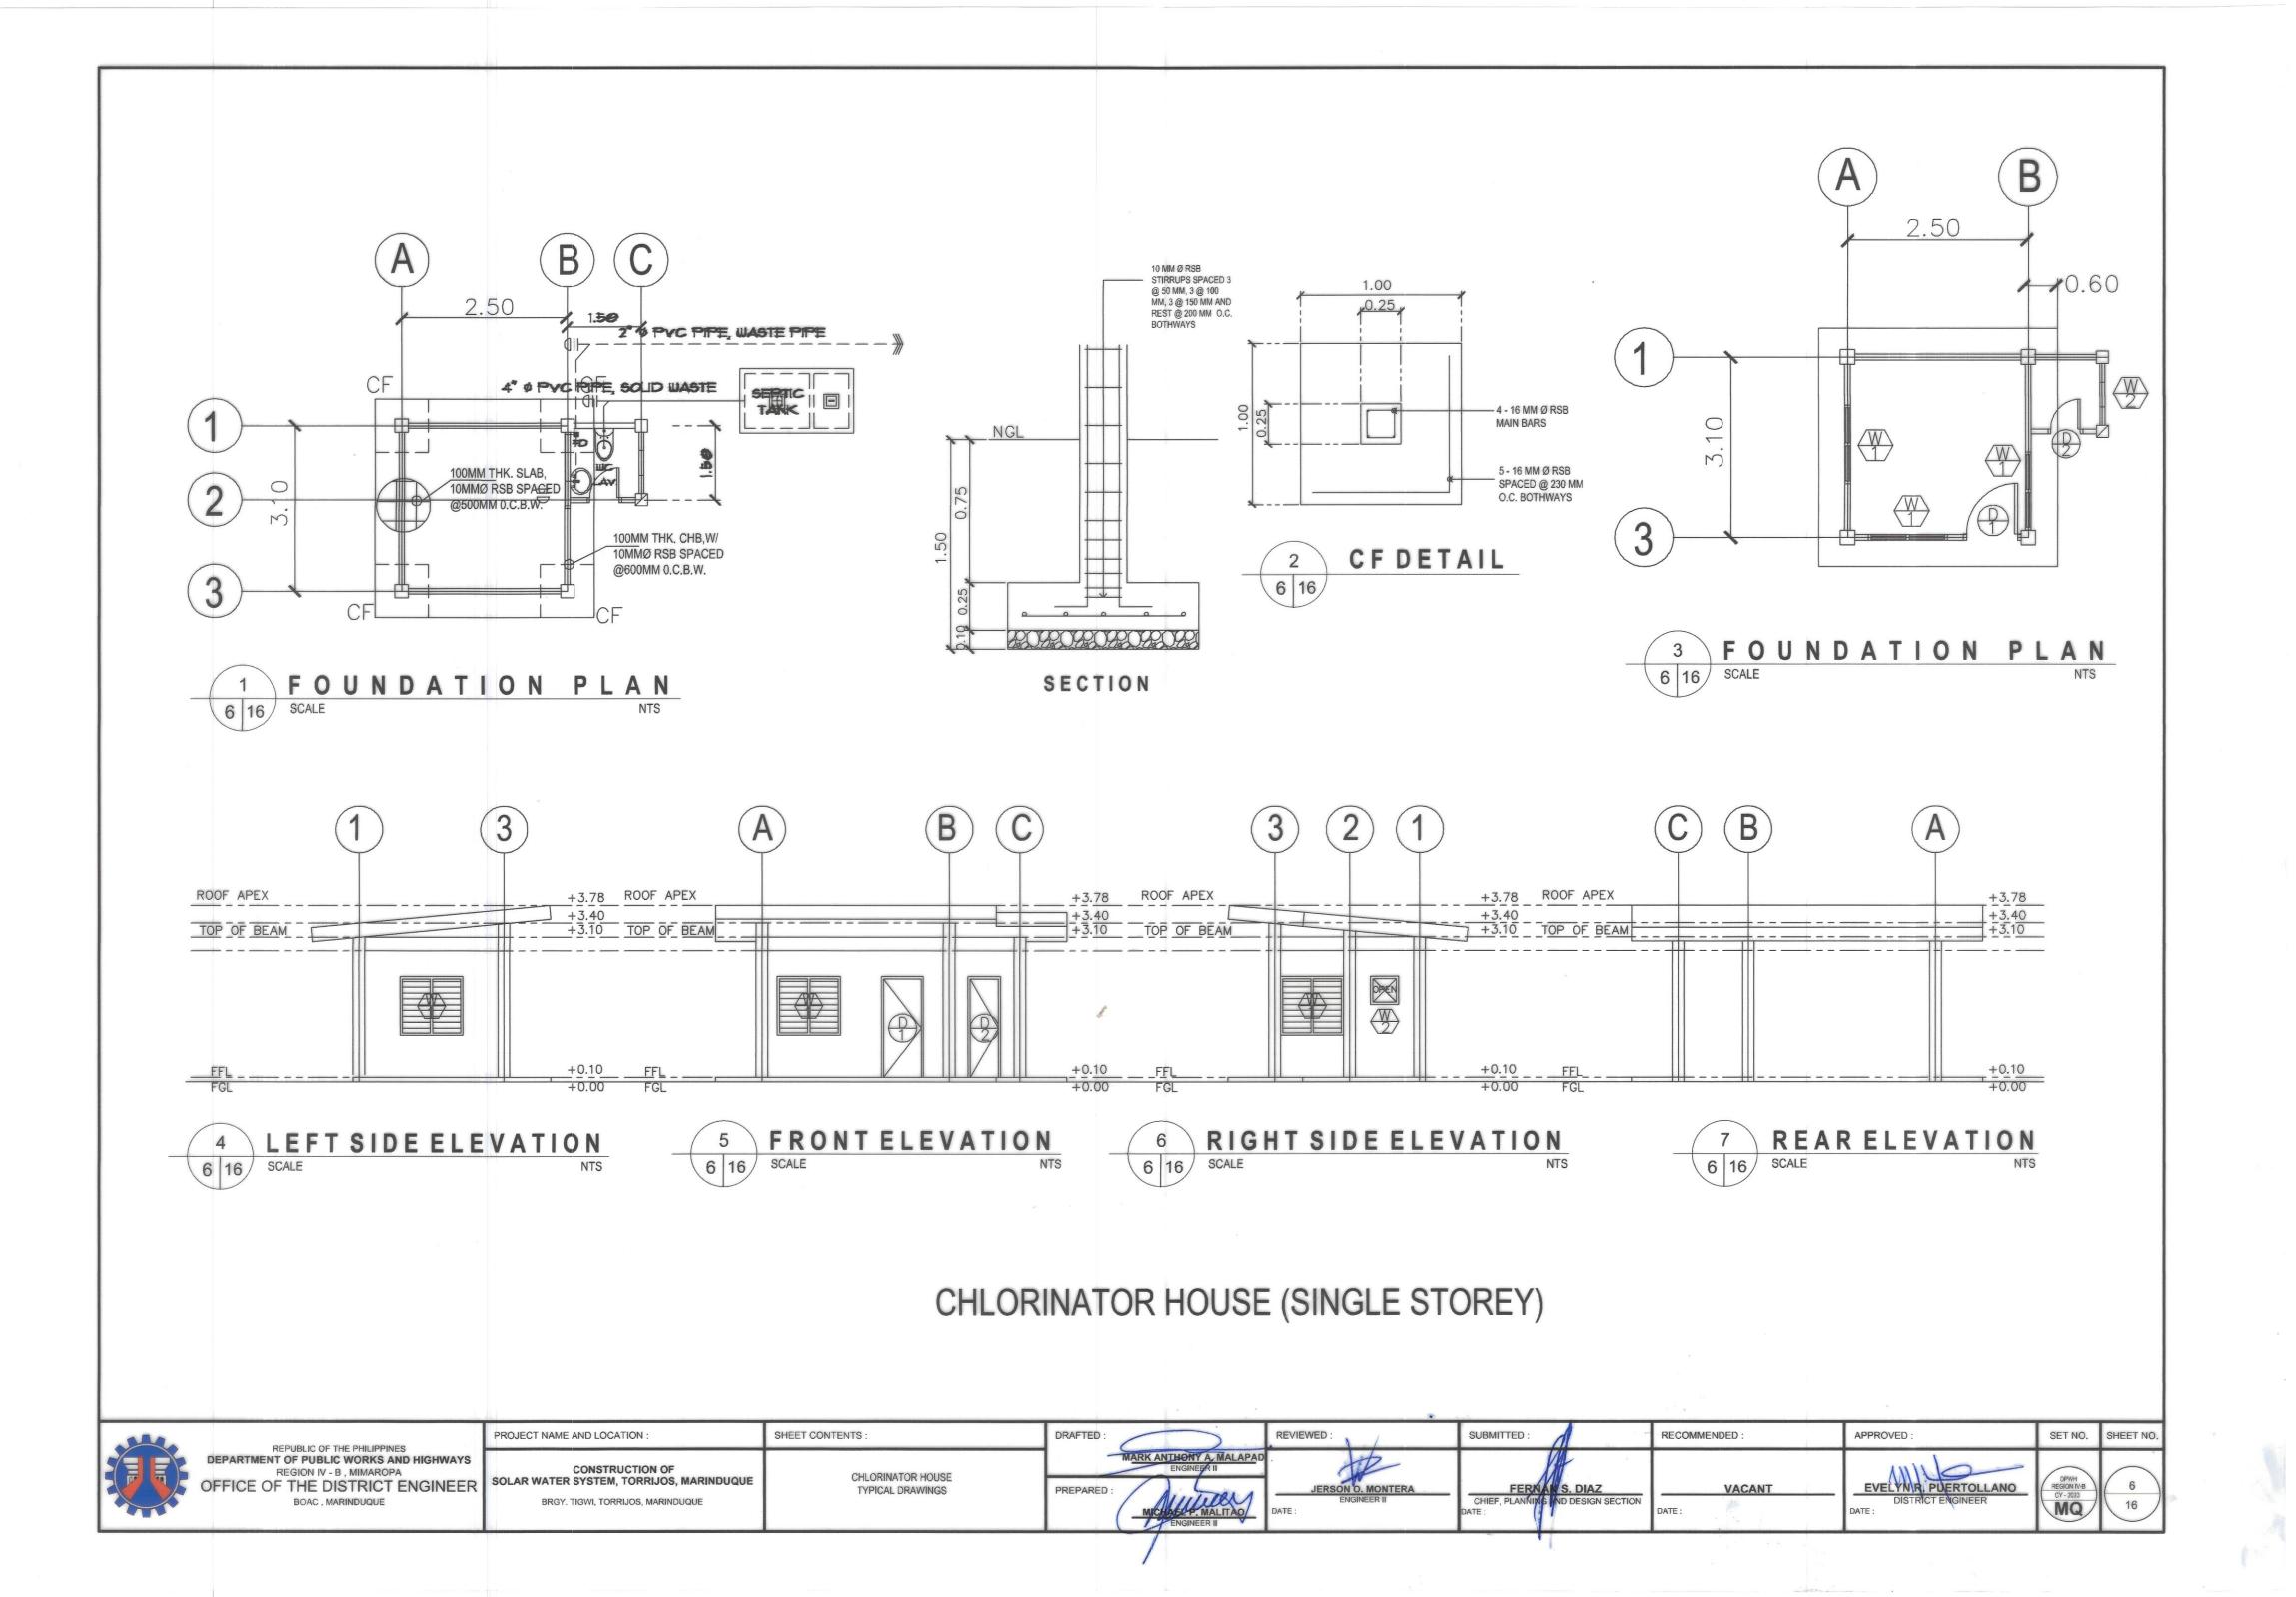

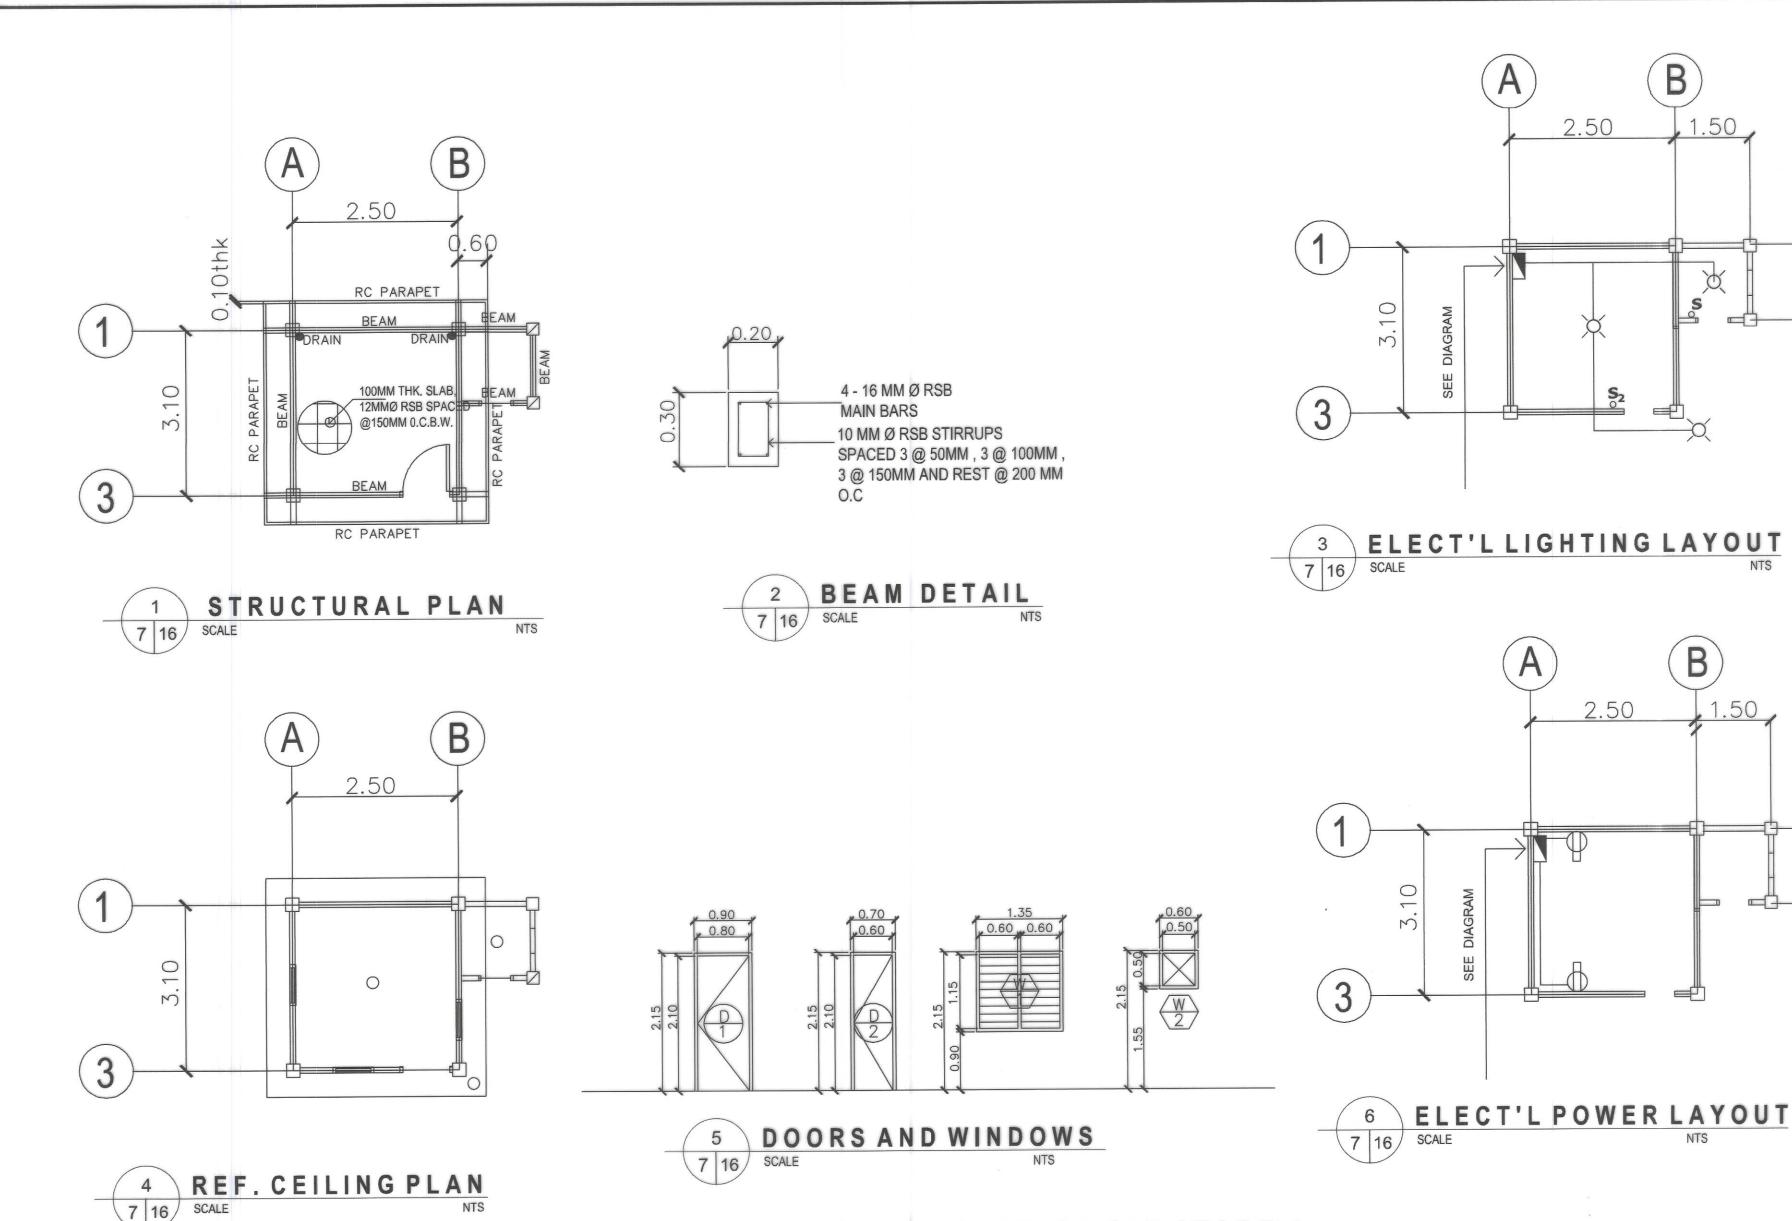



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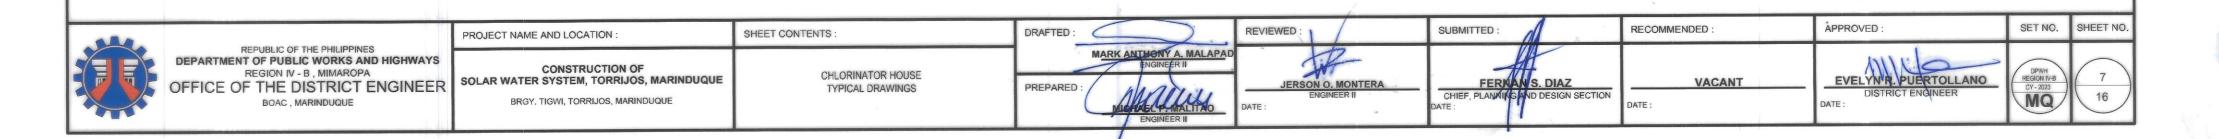
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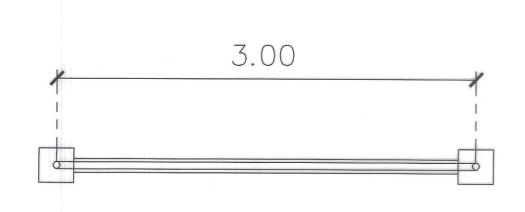
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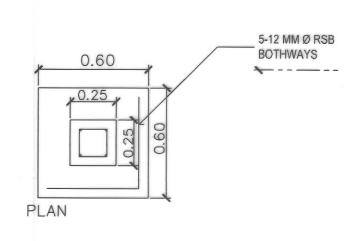
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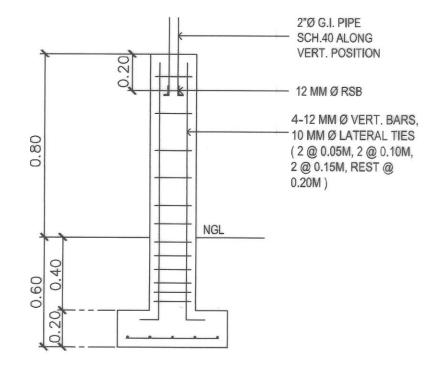
SEE DIAGRAM

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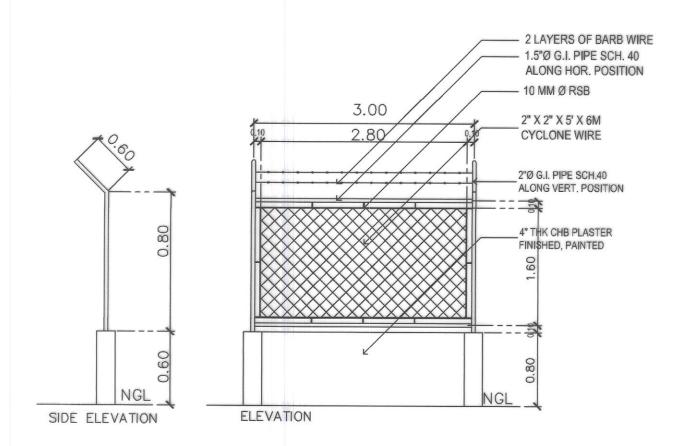














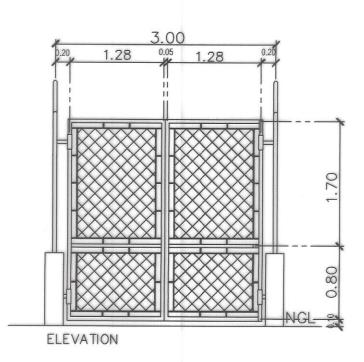

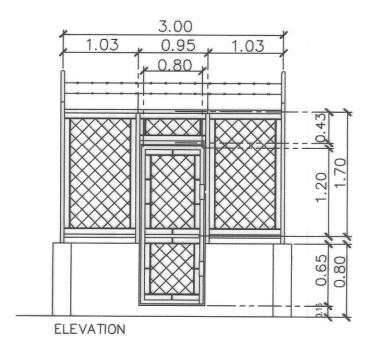

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2	FENCE	DETAIL
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REPUBLIC OF THE PHILIPPINES DEPARTMENT OF PUBLIC WORKS AND HIGHWAY REGION IV - B , MIMAROPA OFFICE OF THE DISTRICT ENGINE BOAC , MARINDUQUE	
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JECT NAME AND LOCATION :	SHEET CONTENTS:
CONSTRUCTION OF AR WATER SYSTEM, TORRIJOS, MARINDUQUE BRGY. TIGWI, TORRIJOS, MARINDUQUE	DETAIL OF STEEL FENCE TYPICAL DRAWINGS

DRAFTED:	-
MARK ANTHONY A. MALAPAD ENGINEER II	
PREPARED:	
MICHALITAO ENGINEER II	

	REVIEWED :	. /	
APAD	-	12	
4	JERS	SON O. MONTERA ENGINEER II	
0	DATE:		

	SUBMITTED:
_	FERMAN S. DIAZ
	CHIEF, PLANNING AND DESIGN : DATE :

VACANT

DATE:

APPROVED:


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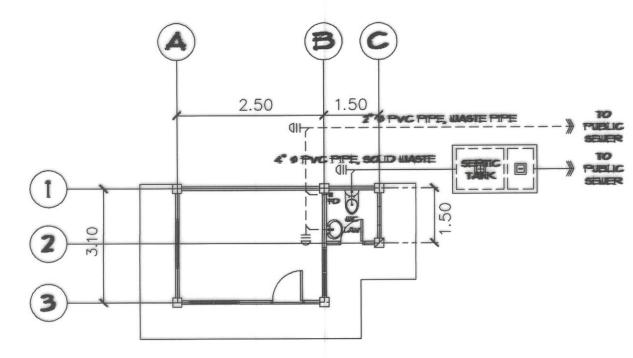
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PUERTOLLANO TRICT ENGINEER




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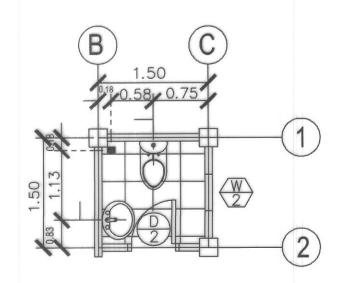







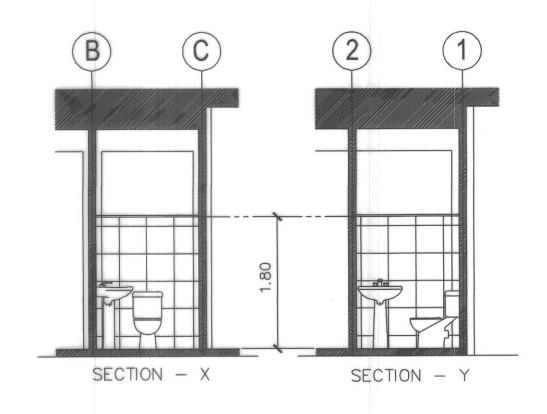

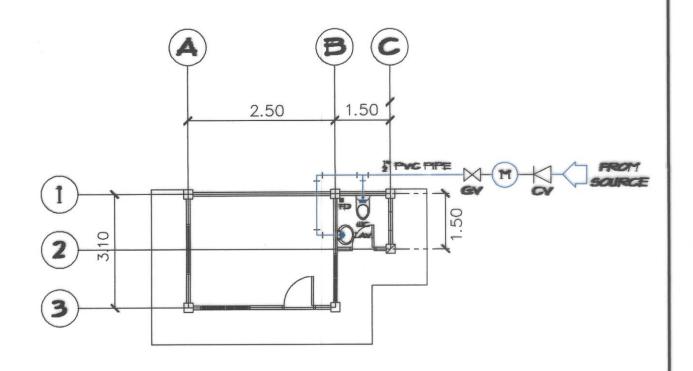
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9 16 SCALE NTS

	REPUBLIC OF THE PHILIPPINES DEPARTMENT OF PUBLIC WORKS AND HIGHWAYS REGION IV - B , MIMAROPA OFFICE OF THE DISTRICT ENGINEER BOAC , MARINDUQUE
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PROJECT NAME AND LOCATION :
CONSTRUCTION OF SOLAR WATER SYSTEM, TORRIJOS, MARINDUQUE
BRGY. TIGWI, TORRIJOS, MARINDUQUE

SHEET CONTENTS:

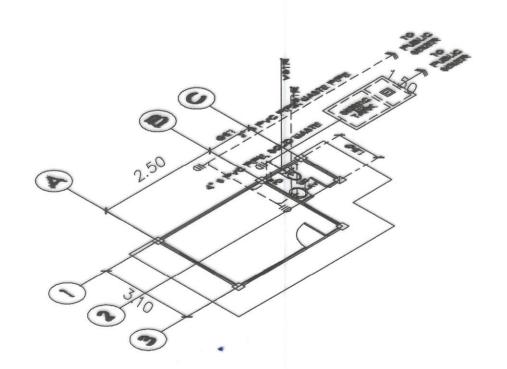
PLUMBING LAY-OUT TYPICAL DRAWINGS

	DRAFTED:
	MARK ANTHONY A. MALAPAD ENGINEER II
	PREPARED :
NEW YORK OF THE REAL PROPERTY.	

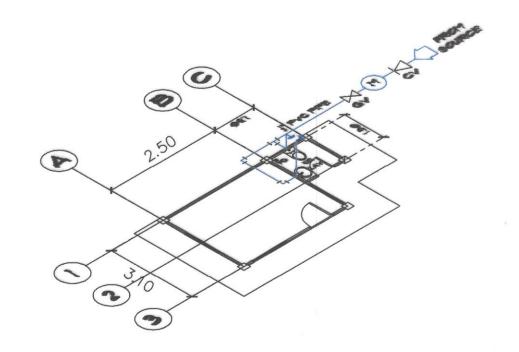	REVIEWED:
A. MALAPAD	12
ALITAS ER II	JERSON O. MONTERA ENGINEER II DATE:

	SUBMITTED;
MONTERA	FERNAN S. DIAZ
EER II	CHIEF, PLANNING AND DESIGN SECTION DATE:

RECOMMENDED:	APPROVED :	SET NO.	SHEET NO.
VACANT DATE:	EVELYN RI PUERTOLLANO DISTRICT ENGINEER DATE:	DPWH REGION IV-B CY - 2023	9 16

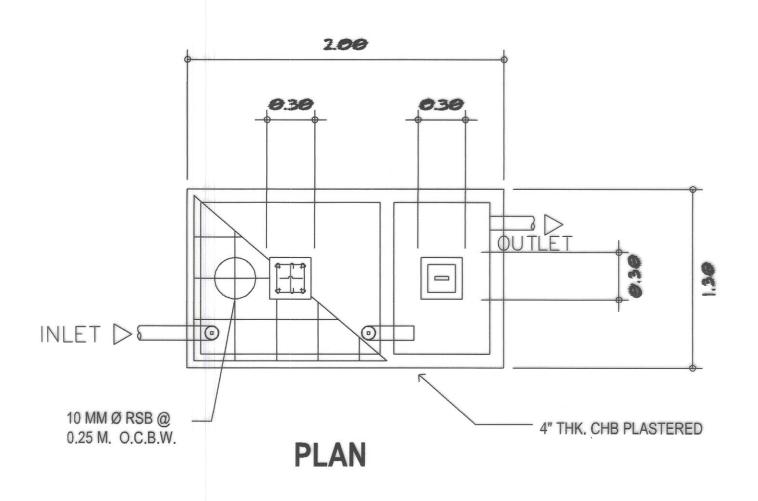


LEGEND


		WATER LINE		FD	FLOOR DRAIN
_		SOLID WASTE BASIN LINE		MH	MANHOLE
_		WASTE BASIN LINE		WC	WATER CLOSET
		REDUCER FITTINGS		F	FAUCET
\boxtimes	GV	GATE VALVE	A	SHO.	SHOWER
	WM	WATER METER		LAV.	LAVATORY
\circ	*****	VVVVEICHETEIC	0/1/	C.O.	CLEAN OUT
	CV	CHECK VALVE		ST	SEPTIC TANK

GENERAL PLUMBING NOTES

- ALL PLUMBING NOTES INCLUDED HEREIN SHALL BE ACCORDANCE WITH THE PROVISION OF THE PLUMBING CODE, NATIONAL BUILDING CODE AND THE LOCAL REGULATIONS OF THE LOCALITY.
- COORDINATE THE DRAWINGS WITH THE OTHER RELATED DRAWINGS AND SPECIFICATIONS. THE ENGINEER AND / OR ARCHITECT SHALL BE NOTIFIED IMMEDIATELY OF ANY DISCREPANCY FOUND HEREIN.
- ALL PIPES SHALL BE INSTALLED AS INDICATED, ANY RELOCATION REQUIRED FOR PROPER EXECUTION OF PLUMBING WORKS SHALL BE WITH THE PRIOR APPROVAL OF THE ENGINEER AND / OR ARCHITECT.
- 4. PROPOSED SANITARY UTILITIES SHALL CONFORM TO THE ACTUAL LOCATION, DEPTH, AND INVERT ELEVATIONS OF ALL EXISTING PIPES AND STRUCTURE AS VERIFIED BY THE CONSTRUCTOR.
- 5. ALL SLOPES FOR HORIZONTAL DRAINAGE SHALL MAINTAIN ONE PERCENT (0.01) AND A HALF (0.008) MINIMUM UNLESS OTHERWISE SPECIFIED.
- 6. WATER SUPPLY PIPE TO FIXTURES SHALL BE SIZED ACCORDANCE WITH THE MANUFACTURERS RECOMMENDATIONS.
- ALL BRANCHES OF FIXTURES OR GROUP OF FIXTURES SHALL BE PROVIDED WITH AIR CHAMBER MADE OF CAPPED VERTICAL EXTENSION PIPE.
- ALL WATER LINES SHALL BE HYDROSTICALLY TESTED AT 100 psi FOR A PERIOD OF TWO
 (2) HOURS BEFORE BURIED OR COVERED GALVANIZED IRON (G.I.) DIRECTLY IN CONTACT WITH THE SOIL SHALL BE PROVIDED WITHTWO COATS OF ASPHALT.

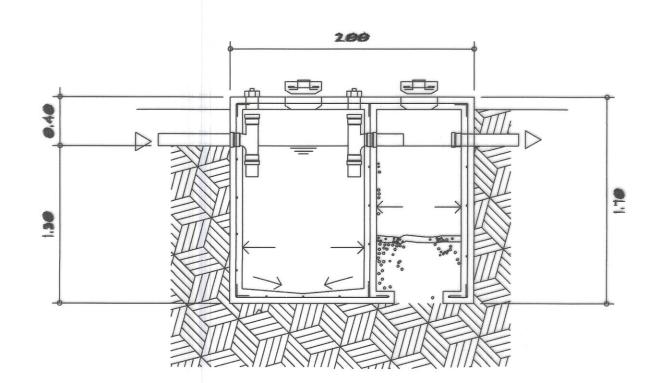



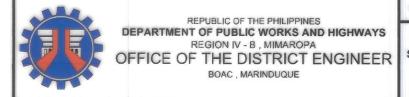


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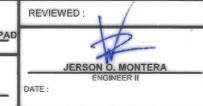
CONSTRUCTION OF
SOLAR WATER SYSTEM, TORRIJOS, MARINDUQUE
BRGY. TIGWI, TORRIJOS, MARINDUQUE

BRGY. TIGWI, TORRIJOS, MARINDUQUE

SHEET CONTENTS:

DETAIL OF SEPTIC TANK
GENERAL PLUMBING NOTES
TYPICAL DRAWINGS



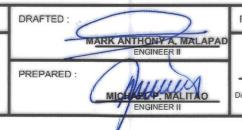

FERNAN S. DIAZ

CHIEF, PLANNING AND DESIGN SECTION DATE:

RECOMMENDED

VA

APPROVED :

EVELYN R RUERTOL

DISTRICT ENGINEER


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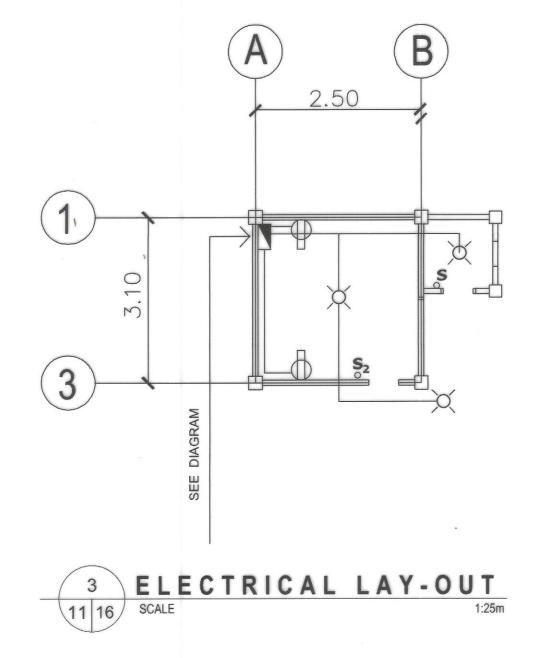
DPWH REGION IV-B CY - 2023

SET NO.

SHEET NO

CIRCUIT NUMBER	LOAD DESCRIPTION	НР		OUTL	ETS			SWITCHES			VOLT.	AMP	VOLTS	CPD	BOL	T-OI	N	CONDUCTORS	CONDUIT	AREA SERVED
		HP	O.L.	MOTOR	c.o.	L.O.	S	S2	53	saw	AMP.	APIP.	VOLIS	AF	P	AT	KAIC	THHN CU STRANDED	CONDUIT	AREA SERVED
	LIGHTING POINTS AND CONVENIENCE OUTLET				1	3	1	1			660	2,87	230V	50	2	20	10	2 # 3,5 mm ² E= 1 # 3,5 mm ²	20 MMØ	CHLORINATOR
FOR MAIN SERVICE ENTRANCE																				
	FOR MAIN SERVICE ENTRANCE CONDUCTOR USE 2NOS. 8.0.0mm² THHN WIRE 1NO. 5.5mm² TW WIRE (G)							FOR	MAI	N DI	SCO	NNEC	CTION EQUIPMENT							



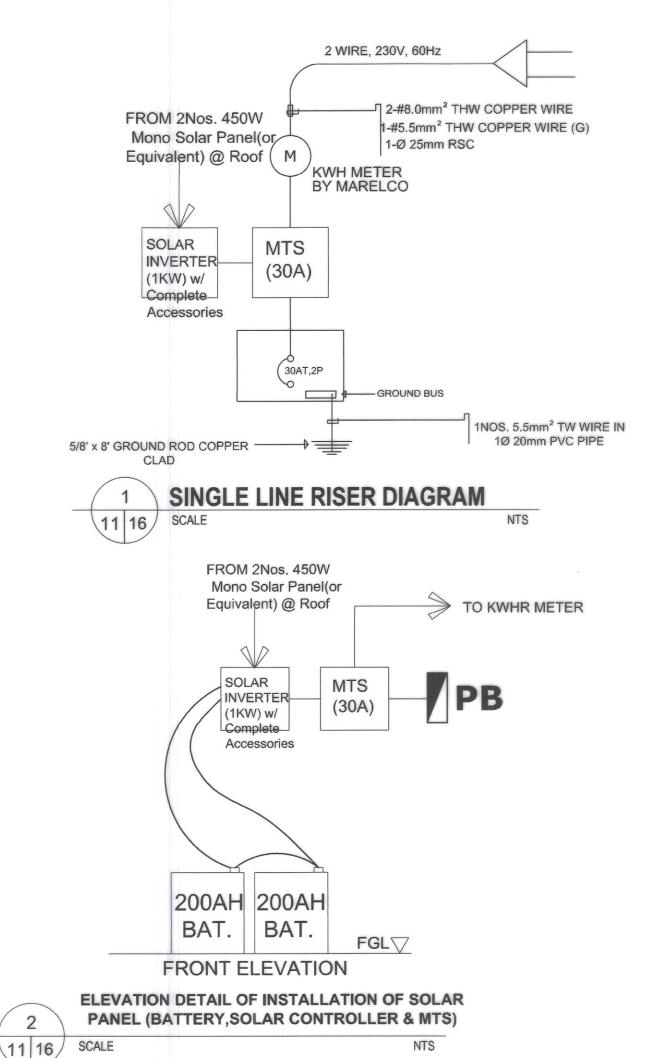

GENERAL NOTES

ALL ELECTRICAL INSTALLATION SHALL BE DONE IN ACCORDANCE WITH THE PROVISIONS OF THE LATEST EDITION OF THE PHILIPPINE ELECTRICAL CODE 2000 EDITION THE LAWS AND ORDINANCES OF THE LOCAL CODE ENFORCING AUTHORITIES AND THE REQUIREMENTS OF THE LOCAL UTILITY

SERVICE TO THE BUILDING SHALL BE 230V, 60HZ, SINGLE PHASE, 2-WIRE

2. MINIMUM SIZE OF CONDUCTORS SHALL BE 230V, 2.00 mm THHN OR TW FOR LIGHTING AND 3.5mm THHN OR TW FOR CONVENIENCE AND POWER CIRCUITS, WITH A MINIMUM CONDUIT OF 20MMØ UPVC

WIRING METHOD SHALL BE AS FOLLOWS:

A. RIGID UPVC PIPE FOR RUNS EMBEDDED IN CONCRETE OR UNDERGROUNDS
B. RIGID UPVC PIPE WITH APPROVED MEANS OF SUPPORT FOR EXPOSED CONDUIT SYSTEM.

C. RIGID UPVC PIPE OR FLEXIBLE UPVC CONDUIT FOR RUNS CONCEALED ON CEILING AND DOUBLE WALLS.

4. UNLESS OTHERWISE INDICATED, MOUNTING HEIGHTS SHALL BE AS FOLLOWS:
LIGHTING SWITCHES ----- 1.40m ABOVE FFL @ CENTER
PANEL BOARD 1.50m ----- ABOVE FFL @ CENTER
CONVENIENCE OUTLET ----- 0.30m ABOVE FFL @ CENTER
SPECIAL PURPOSE OUTLET ---- AS RECOMMENDED BY THE EQUIPMENT
MANUFACTURER.

5. ALL MATERIALS TO BE USED SHALL BE BRAND NEW AND SHALL BE INSTALLED IN APPLICATION FOR WHICH THEY ARE INTENDED.

6. ALL BOXES FOR ENCLOSURE TO BE INSTALLED OUTDOOR SHALL BE RAIN PROOF NEM, 3R RATING OR BE PROVIDED WITH EQUIVALENT PROTECTION.

7. ALL ELECTRICAL INSTALLATION HEREIN SHALL BE DONE UNDER THE SUPERVISION OF A LICENSED ELECTRICAL ENGINEER OR A REGISTERED MASTER ELECTRICIAN.

LEGEND:

⇒ SERVICE ENTRANCE

DUPLEX CONVINIENCE OUTLET W/ GROUND AND SHUTTER

CEILING LIGHT OUTLET WITH 15W LED
BULB

PANEL BOARD 30AT, 2P CIRCUIT
BREAKER BOLT-ON IN NEMA-1
ENCLOSURE

KWHR METER IN 5METERS CONCRETE PEDESTAL

S ONE GANG ONE WAY SWITCH

TWO GANG ONE WAY SWITCH

REPUBLIC OF THE PHILIPPINES	PROJECT NAME AND LOCATION :	SHEET CONTENTS:	DRAFTED :	Minn	REVIEWED:	SUBMITTED:	RECOMMENDED:	APPROVED :	SET NO.	SHEET NO.
DEPARTMENT OF PUBLIC WORKS AND HIGHWAYS	CONSTRUCTION OF SOLAR WATER SYSTEM, TORRIJOS, MARINDUQUE BRGY. TIGWI, TORRIJOS, MARINDUQUE	ELECTRICAL LAY-OUT TYPICAL DRAWINGS	PREPARED:	ADRIAN V. LOZANO ENGINEER II	MICHAEL P. MALITAO ENGINEER II	FERMAN S. DIAZ CHIEF, PLANNING AND DESIGN SECTION DATE:	VACANT DATE:	EVELYN R PUERTOLLANO DISTRICT ENGINEER DATE:	DPWH REGION IV-B CY - 2023	11 16


GENERAL NOTES:

- 1. ALL EQUIPMENT SHALL BE INSTALLED IN APPROXIMATE LOCATION AS SHOWN ON THE DRAWINGS.
- 2. INSTALLATION OF ALL WORKS SHALL BE DONE IN A NEAT AND WORKMANLIKE MANNER, IMPROPERLY SETWORK OR FINISH AS DETERMINED BY THE ARCHITECT SHALL BE REMOVED AND REPLACED AT NO EXTRA COST.

12 16/

SCALE


- 3. ALL MATERIALS TO BE USED SHALL BE BRAND NEW AND CLEAN.
- DEVIATIONS AND REVISIONS FROM PLANS SHALL BE REFERRED TO THE ARCHITECT FOR REVIEW AND APPROVAL.
 ALL NECESSARY GOVERNMENT PERMIT SHALL BE SECURED AND PAID FOR BY THE CONTRACTOR.
- 6. ALL DIMENSION ARE IN MILLIMETER UNLESS OTHERWISE SPECIFIED.
- 7. ALL MECHANICAL WORKS SHALL BE IN ACCORDANCE WITH THE LATEST MECHANICAL ENGINEER'S CODE ASVE AND ASHRAE STANDARD.
- 8. MECHANICAL CONTRACTOR SHALL OBSERVED ALWAYS SAFETY AND ORDERLINESS.
- 9. MECHANICAL CONTRACTOR SHALL VERIFY SITE PRIOR TO ACTUAL INSTALLATION.

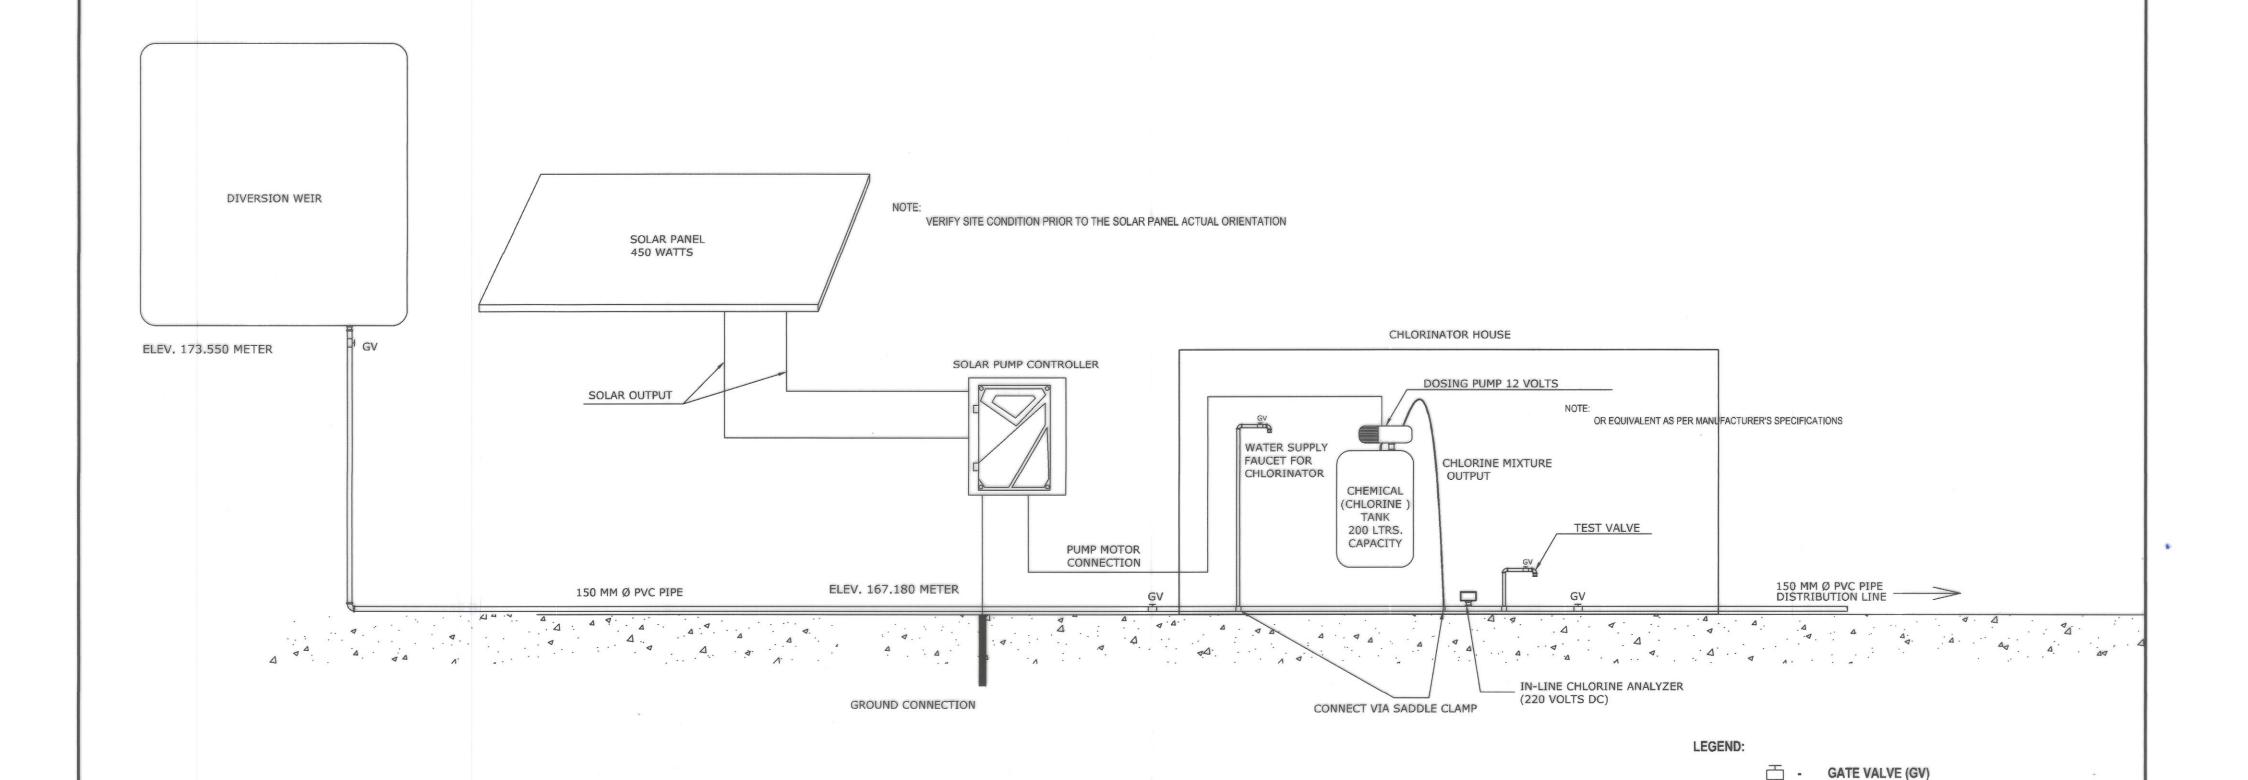



PROJECT NAME AND LOCATION: SHEET CONTENTS : DRAFTED: REVIEWED: RECOMMENDED: APPROVED: SET NO. SHEET NO. SUBMITTED: REPUBLIC OF THE PHILIPPINES DEPARTMENT OF PUBLIC WORKS AND HIGHWAYS **CONSTRUCTION OF** SOLAR POWERED REGION IV - B , MIMAROPA SOLAR WATER SYSTEM, TORRIJOS, MARINDUQUE OFFICE OF THE DISTRICT ENGINEER WATER SYSTEM SCHEMATIC DIAGRAM 12 FERNAN S. DIAZ
CHIEF, PLANNING AND DESIGN SECTION VACANT PREPARED: TYPICAL DRAWINGS BRGY. TIGWI, TORRIJOS, MARINDUQUE BOAC, MARINDUQUE

TYPICAL SOLAR POWERED WATER SYSTEM


SCHEMATIC DIAGRAM

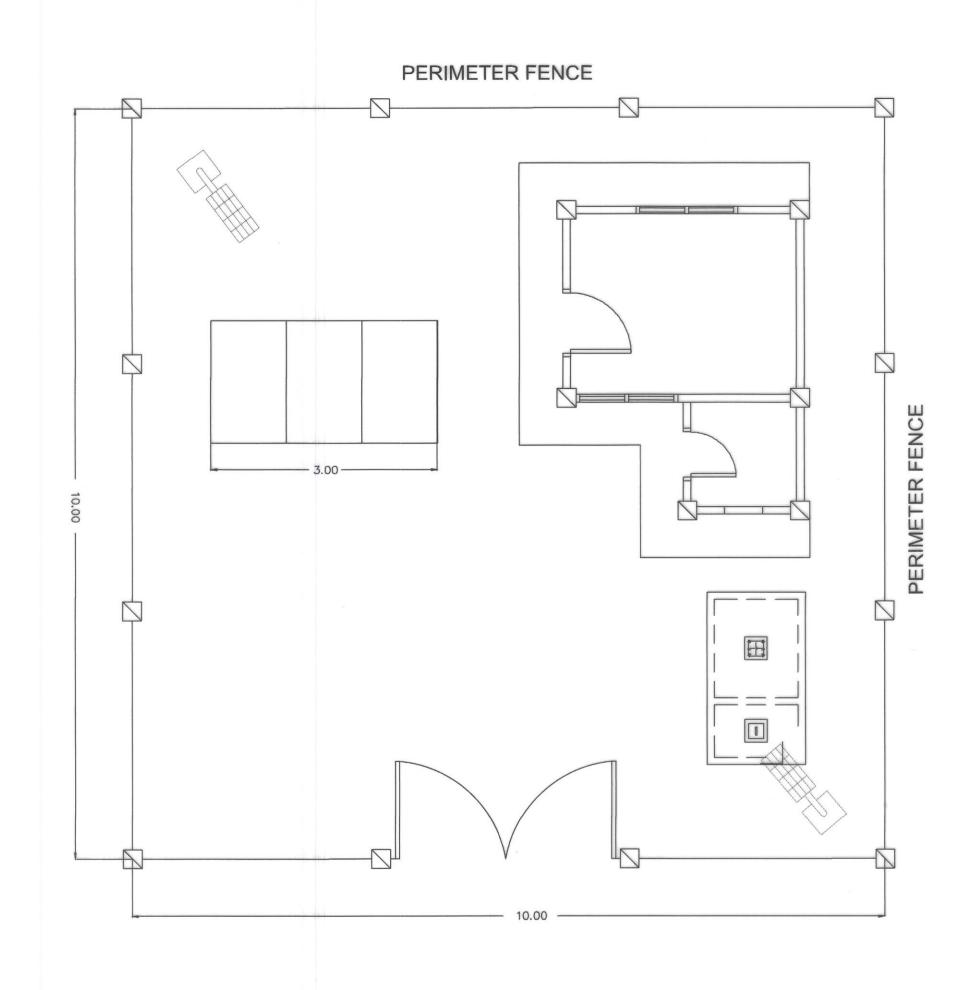

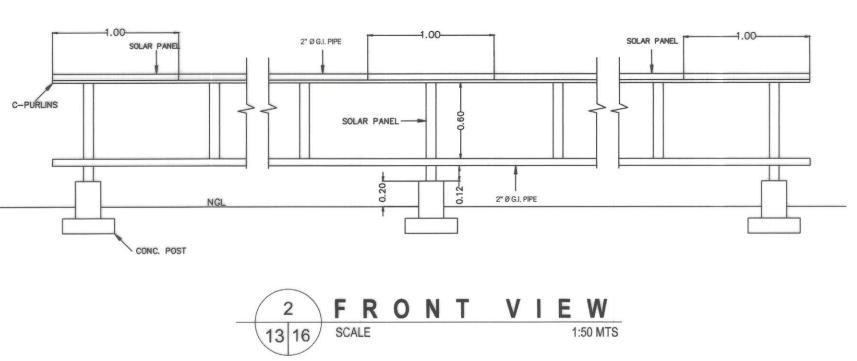

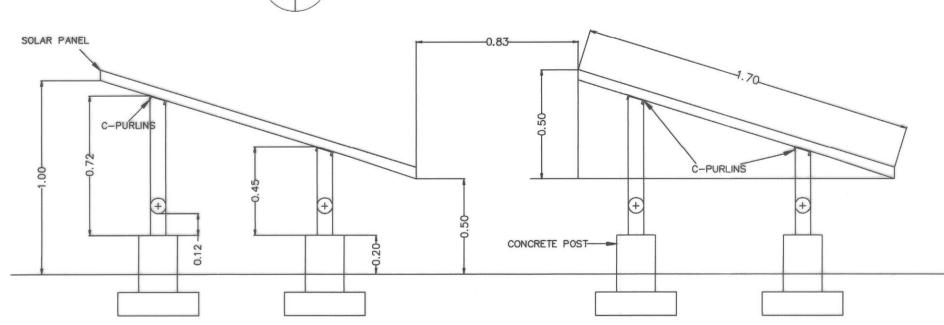

3 SIDE VIEW PLAN
13 16 SCALE 1:40 MTS

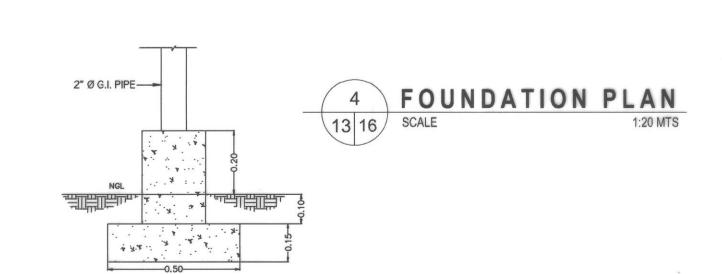



		No.			/					
.244.	REPUBLIC OF THE PHILIPPINES	PROJECT NAME AND LOCATION :	SHEET CONTENTS:	DRAFTED:	REVIEWED:	SUBMITTED:	RECOMMENDED :	APPROVED :	SET NO.	SHEET NO.
	DEPARTMENT OF PUBLIC WORKS AND HIGHWAYS	CONSTRUCTION OF SOLAR WATER SYSTEM, TORRIJOS, MARINDUQUE BRGY. TIGWI, TORRIJOS, MARINDUQUE	SOLAR PANEL TYPICAL DRAWINGS	PREPARED: MICHAELE MALHAO ENGINEER II	JERSON O. MONTERA ENGINEER II DATE :	FERNAN S. DIAZ CHIEF, PLANNING AND DESIGN SECTION DATE:	VACANT	EVELYN RI PUERTOLLANO DISTRICT ENGINEER DATE:	DPWH REGION IV-B CY - 2023	13 16


LED SOLAR LAMP SPECIFICATIONS OVERVIEW


LAMP BRIGHTNESS	70 WATTS
LED STRUCTURE	200PCS IN 4 LED PCB 50X4 SMD 3030 BAT-WING POLARIZED LENS 120 DEGREES VIEWING ANGLE
LUMENS	8,000 - 10,000 LUMENS
LIFESPAN	50,000 HOURS
ССТ	6000K COLOR TEMPERATURE
CHARGE CONTROLLER	MPPT, 30A CHARGE CURRENT INTELLIGENT LED POWER CONTROL W/ 120W MAXIMUM OUTPUT POWER AND 10-STEP LOAD WORKING MODE
BATTERY	360WH, ORIGINAL LIFEPO4 (LITHIUM ION PHOSPHATE), GREATER THAN 3000 CYCLES AT 80% DOD, W/ 20% AGING FACTOR
SOLAR PANEL	MONOCRYSTALLINE, 90W, CELL EFFICIENCY GREATER 18%, GREATER THAN 70% FILL FACTOR TEMPERED GLASS
BODY MATERIAL	HIGH-PRESSURE DIE-CAST ALUMINUM ALLOY, IP65 ENCLOSURE
BODY COLOR	EPOXY PAINT DARK GREY COLOR CASING W/ COLLAR LIGHT(BLUE LED)
WIND STRENGTH	60M/S OR 200KG PER SQM EPA NOT MORE THAN 0.5 SQ.M
DIMENSION	LENGTH: 1000-1100MM WIDTH: 500-550MM THICKNESS: 140-150MM
WORKING TIME	12 HRS ; 3-5 CLOUDY / RAINY DAYS
CHARGING TIME	6 HOURS EFFECTIVE SUNSHINE
TOTAL WEIGHT	LESS THAN 25KG
WARRANTY	5 YEARS



ARM DIAMETER	3 INCHES
TOP DIAMETER	3 INCHES
BOTTOM DIAMETER	6 INCHES
TOTAL POLE HEIGHT	6 METERS
ARM LENGTH	1.5 METERS
BASE PLATE	320MMX320MMX16MM
FINISH	HOT DIP GALVANIZED



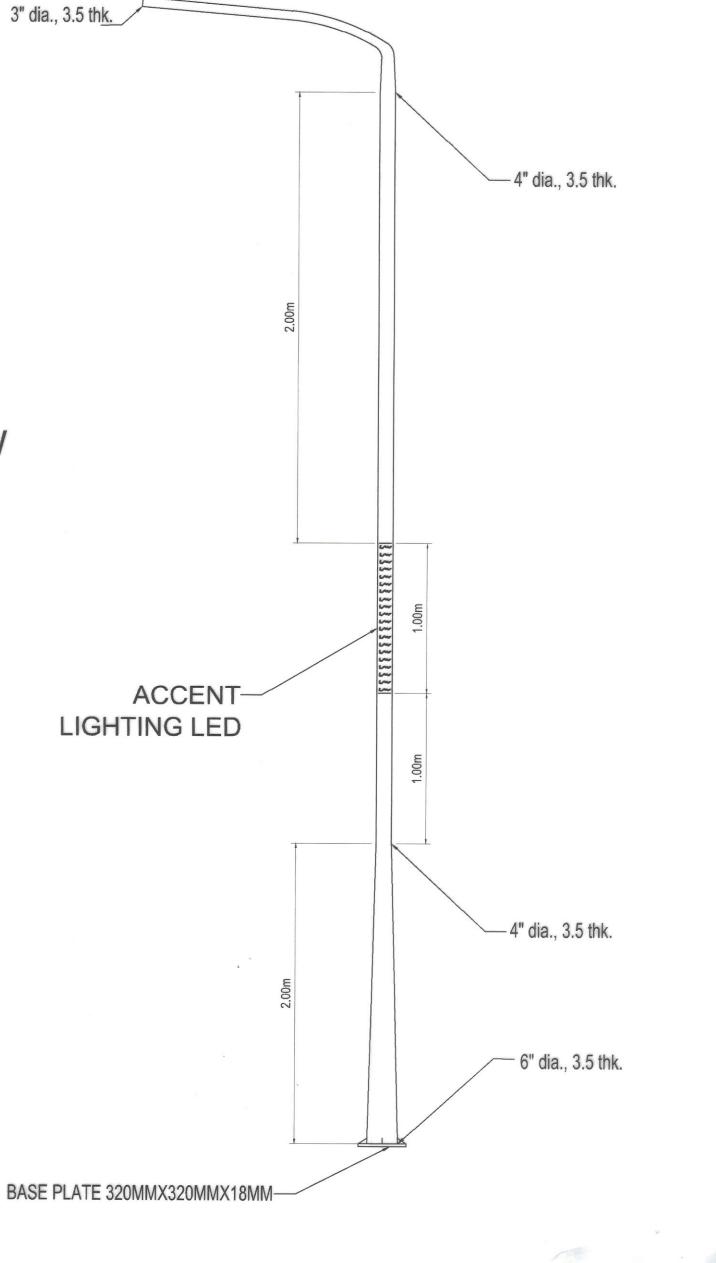

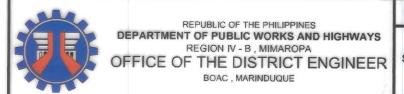

PROJECT NAME AND LOCATION:

CONSTRUCTION OF
SOLAR WATER SYSTEM, TORRIJOS, MARINDUQUE

BRGY. TIGWI, TORRIJOS, MARINDUQUE

SOLAR LIGHT TYPICAL DRAWINGS

SHEET CONTENTS:

PREPARED:

REVIEWED:

MICHAELE-MALITAO

ENGINEER II

FERMAN S. DIA.
CHIEF, PLANNING AND DESIG

RECOMMENDED :


VACANT


DATE :


EVELYN R. PUERTOLLANO
DISTRICT ENGINEER
DATE:

SET NO. SHEET NO.

| DPWH | REGION IV-B | 14 | 16 | 16 | 16 |

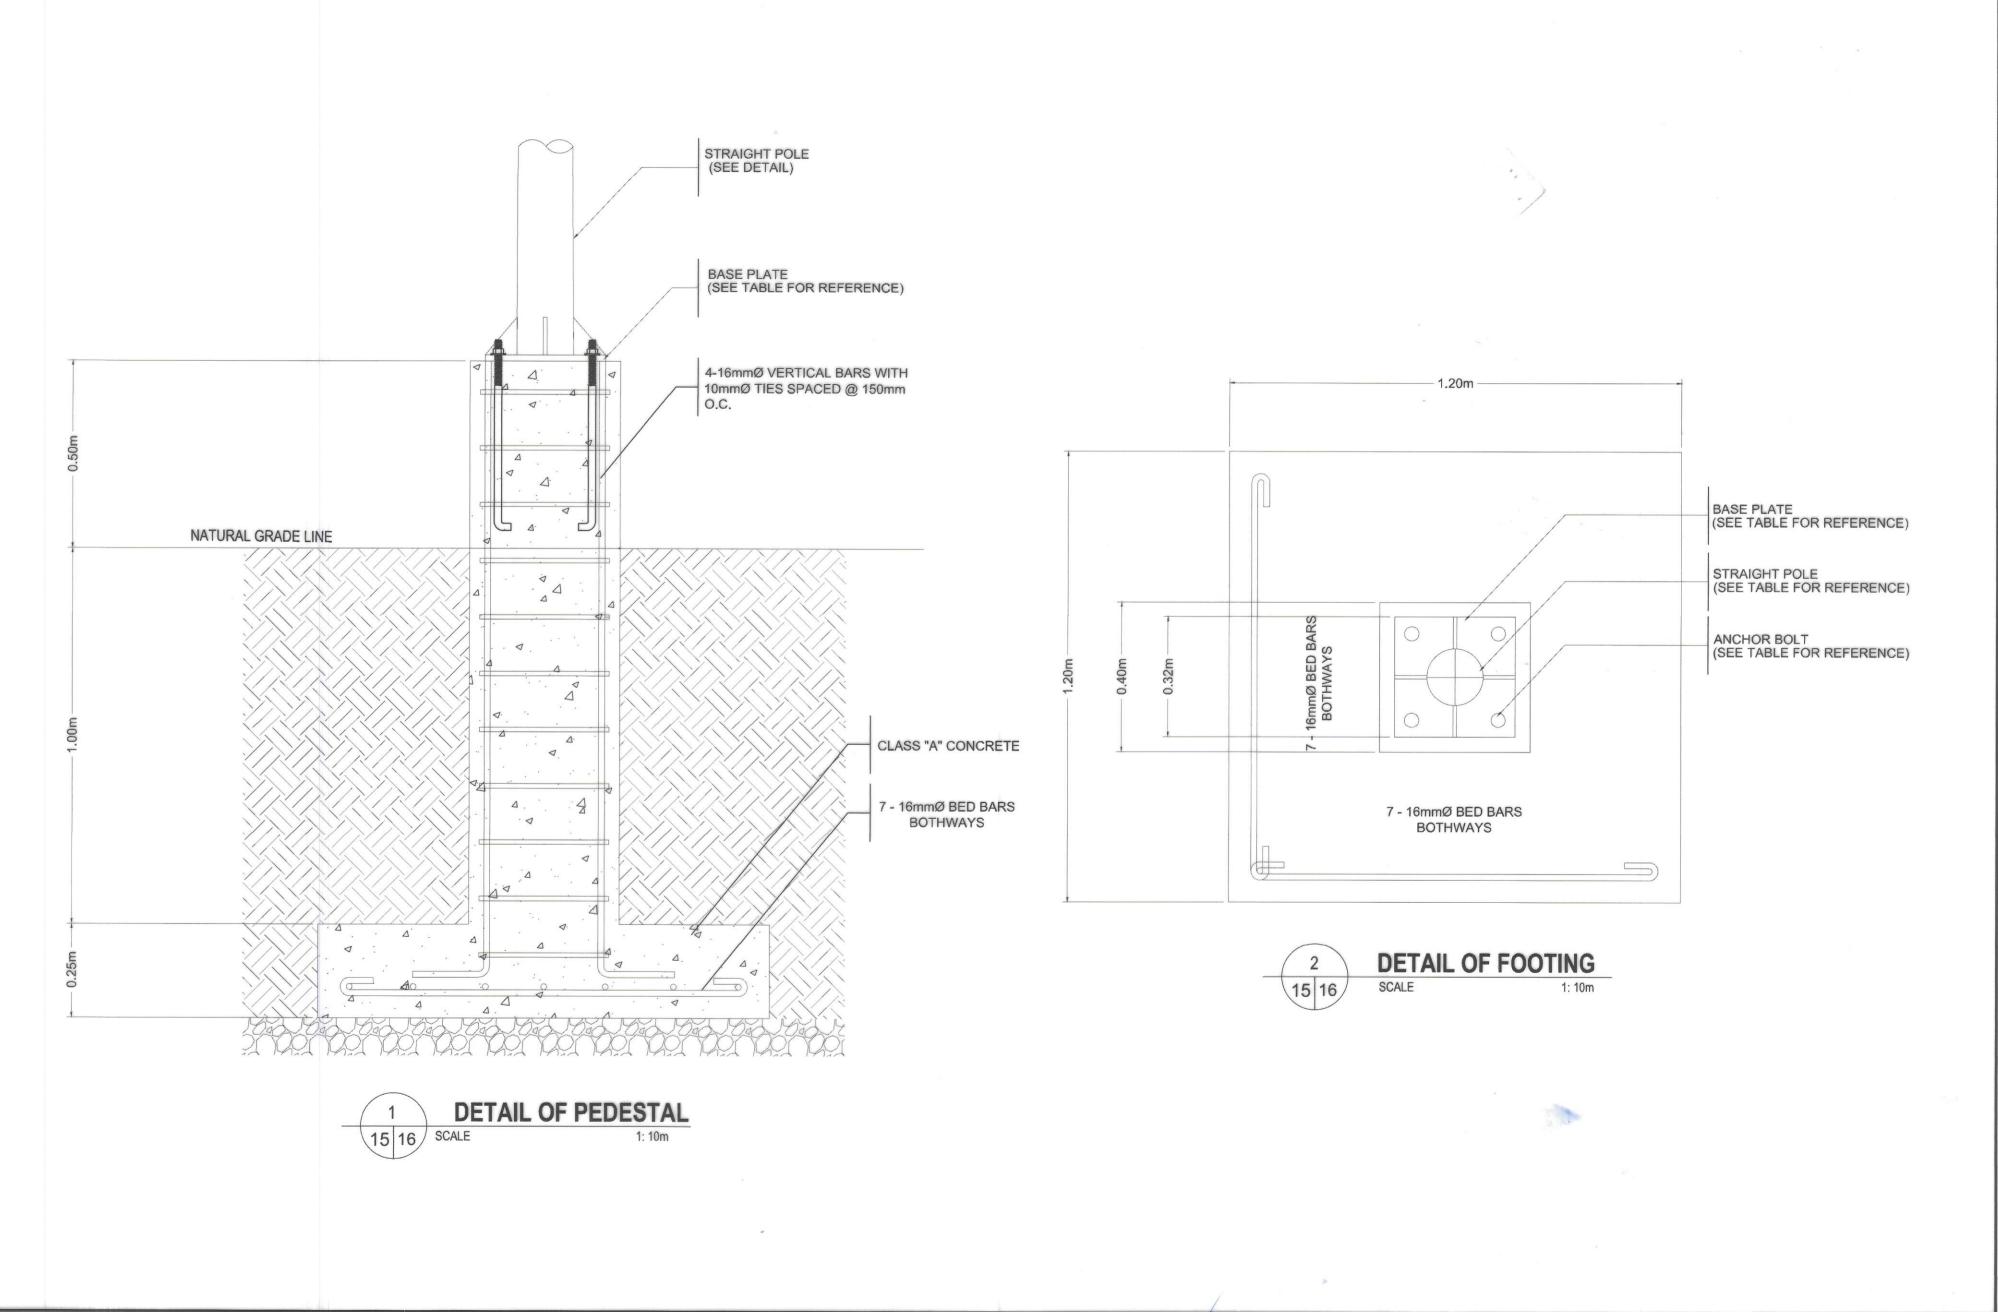

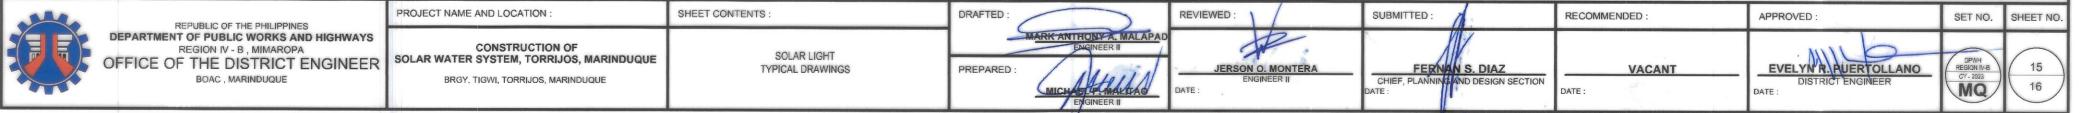

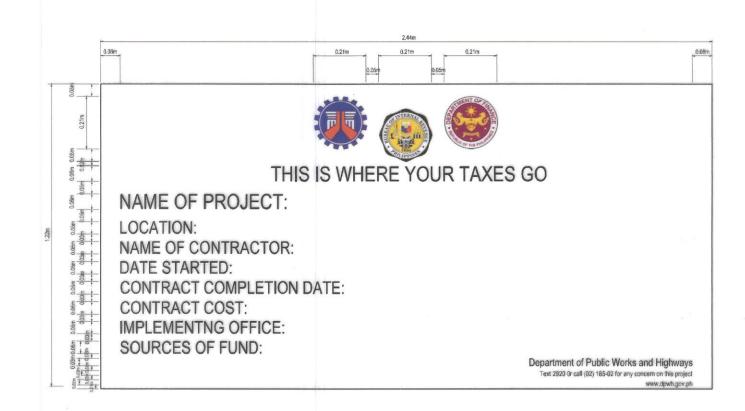






DETAIL OF BILLBOARD

NOTES:

- 1. THE INSTALLATION OF THE REQUIRED STANDARD BILLBOARD SIZE (1200MM X 2400MM / 4 FT. X 8FT.) FOR ALL PROJECTS SHALL BE STRICTLY ENFORCED.
- 2. NO POLITICAL BILLBOARDS SHALL BE ALLOWED TO BE INSTALLED 100 METERS BEFORE AND 100 METERS AFTER ALL DPWH PROJECTS AND IN BETWEEN THE PROJECT LIMITS OR WITHIN THE ROAD RIGHT OF WAY.
- 3. DPWH CONTRACTORS SHALL NOT BE ALLOWED TO PLACE NAMES OF POLITICIANS ON THEIR EQUIPMENT OR CARRY POLITICAL BILLBOARD ON THEIR EQUIPMENT.

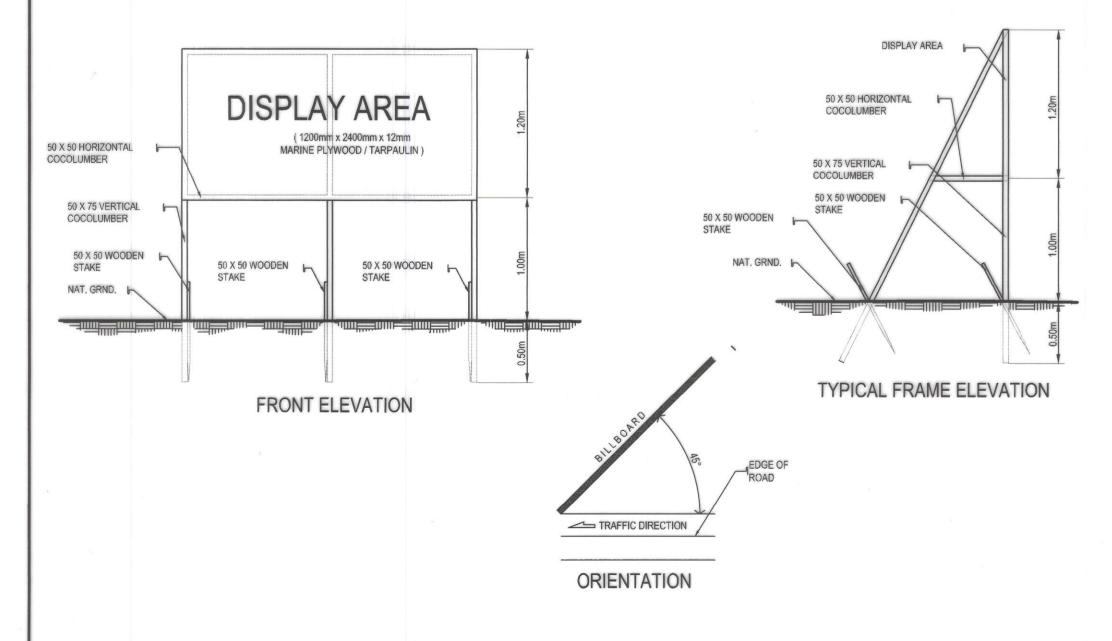


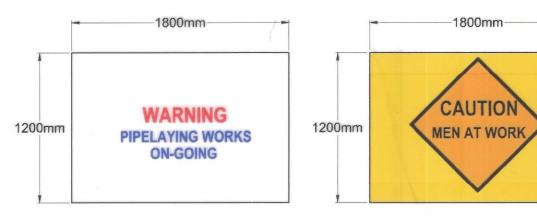

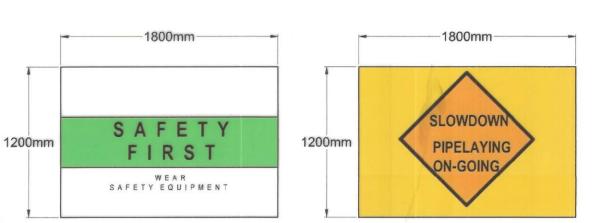






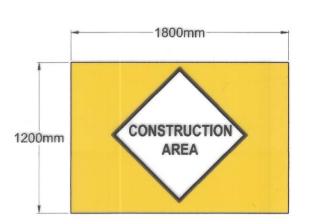



2 WATERWORKS CONSTRUCTION SIGNAGE 16 16 NOTE: SIGNS SHALL BE MADE FROM RETROFLECTIVE

NOTE: SIGNS SHALL BE MADE FROM RETROFLECTIVE SIGN FACE MATERIAL AS PER DO 13 SERIES OF 2018

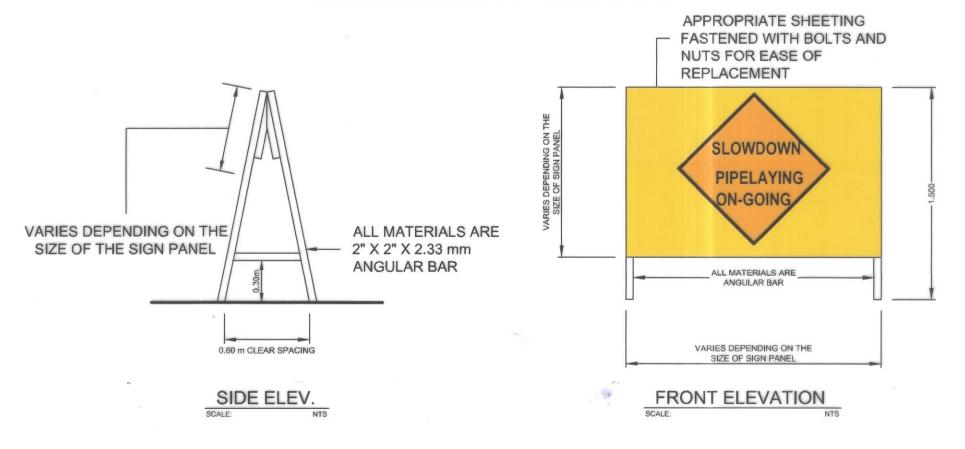

SIGNAGE INSTALLATION DETAIL

