

### LORMELYN E. CALUDIO

Regional Executive Director DENR MIMAROPA Region

### THROUGH: FELIZARDO B. CAYATOC

Provincial Environment and Natural Resources Officer Sta. Monica, Puerto Princesa City, Palawan

PEDRO A. VELASCO

Community Environment and Natural Resources Officer Sta. Monica, Puerto Princesa City, Palawan

Ma'am;

Good Day!

Yurich Builders and Construction Supply has been awarded of a project for the City of Puerto Princesa thru DPWH- Region 4-B entitled "Construction of Rizal Avenue Extension Boardwalk located at Barangay Bancao-Bancao, Puerto Princesa City, Palawan". This is a 600 meters Boardwalk channeling from end of the existing pavement of Rizal Avenue Extension going to the scenic view of Puerto Princesa Bay.

However, during the conduct of survey and as-staking, there is a portion of at least around 10 meters of mangrove area where the boardwalk parking area is to be constructed. As per initial count, there are Thirty-Four (34) Mangrove trees that might be affected of the project development.

The proponent barangay, DPWH-Region 4B and the 3<sup>rd</sup> District wish to continue with the boardwalk construction as this may promote tourism in the area.

With this, may we request a clearance from your good Office or seek legal advice on how to go about with the mangrove portion in the area where the boardwalk is to be constructed, given the Presidential Proclamation 2152.

Attached is the plan for the boardwalk project and pictures of the mangrove area that may be affected.

Respectfully yours,

BERNARDO B. GO JR. Owner/ Proprietor

Yurich Builders and Construction Supply



### **TRANSMITTAL**


June 20, 2023


NO.	PROJECT	CONTRACTOR	TYPE OF DOCS	REMARKS	NOTE
1	BAC INFRA 2023-06-16	YURICH BUILDERS AND	REQUEST LETTER FOR CLEARANCE (BOARDWALK BRGY. BANCAO- BANCAO, PPC)		
2	Drainage System, Barangay Bancao- Bancao, Puerto Princesa City	30.72	ANNEX A		
3			ANNEX B ANNEX C		

PREPARED BY : ( ) WYY
VICTORINA BADILLA


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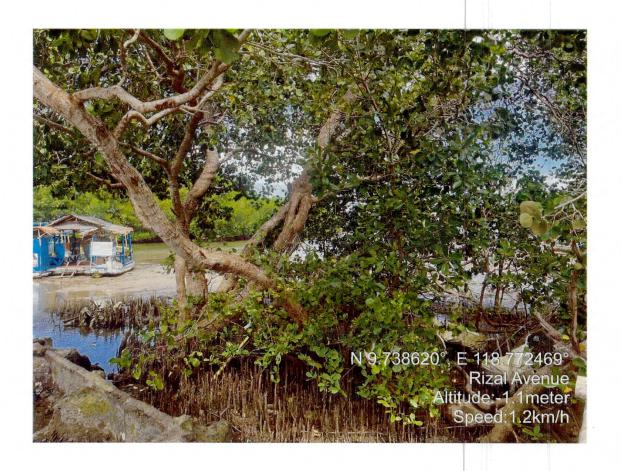
ANNEX A Mangrove Area



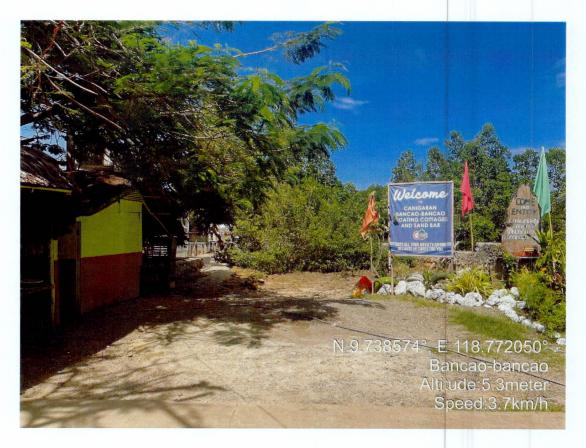

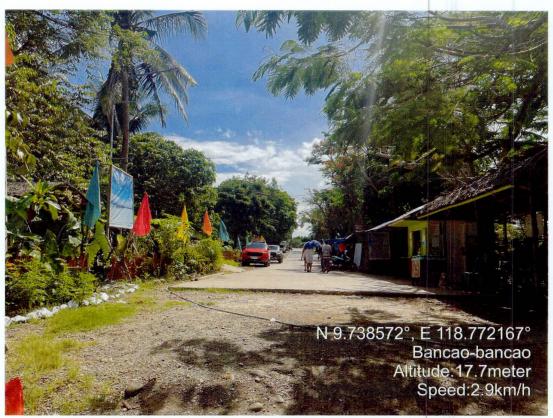



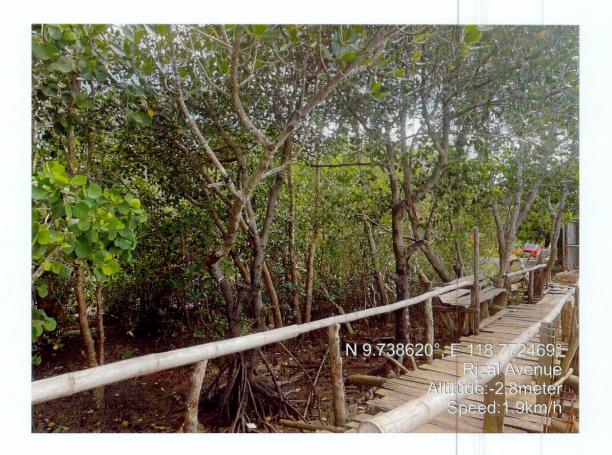

ANNEX B
PERSPECTIVE









# REPUBLIC OF THE PHILIPPINES

# DEPARTMENT OF PUBLIC WORKS AND HIGHWAYS REGIONAL OFFICE IV - B, MIMAROPA

EDSA, Diliman, QUEZON CITY

C.Y. 2023 PROJECT

DETAILED ENGINEERING DESIGN PLAN FOR THE CONVERGE AND SPECIAL SUPPORT PROGRAM

ACCESS ROADS AND/OR BRIDGES FROM THE NATIONAL ROAD/S LEADING TO SUSTAINABLE INFRASTRUCTURE PROJECTS ALLEVIATING GAPS (SIPAG) MAJOR/STRATEGIC PUBLIC BUILDINGS/ FACILITIES

CONSTRUCTION OF RIZAL AVENUE EXTENSION BOARDWALK BARANGAY BANCAO-BANCAO, PUERTO PRINCESA CITY, PALAWAN PUERTO PRINCESA CITY, PALAWAN

STA. 00+000.00 - STA. 00+600.00 PROJECT LENGTH: 600.00 L.M.

PROJECT ID: P00736310LZ

SUBMITTED:

RECOMMENDED

GENE RYAN A. ALTEA CHIEF, PLANNING AND DESIGN DIVISION

DATE:

DATE:

MELQUIADES H. STO. DOMINGO ASSISTANT REGIONAL DIRECTOR

APPROVED:


GERAILD A. PACANAN, CESO III

DATE:

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OFFICE OF THE REGIONAL DIRECTOR EDSA, DILMAN, QUEZON CITY	DEPARTMENT OF PUBLIC WORKS AND HIGHWAYS REGION IV-B	REPUBLIC OF THE PHILIPPINES
MADYISTRATEGIC PUBLIC BUIL CHICASIFACILITIES CONSTRUCTION OF ROLL, AVENUE EXTENSION SOLISTIMUS GARANGAY BANCLAG-BANCLA, PUBLIC OF ROCESA CITY, PALAWAN PUERTO PRINCESA CITY, PALAWAN	DEFALED EXCHEENING DESIGN PLANFOR THE CONVERGE AND SHECKAL SUPPORT PROCRAM. SUSTAINABLE HERPASTRUCTURE PROJECTS ALEXANTING CAPS (SIPAG) ACCESS ROADS ANDOR BRIDGES FROM TO ACCESS ROADS ANDOR BRIDGES FROM TO	PROJECT NAME AND LOCATION:
INDICA OF OPERE	MARK OR OHERT	SHEET CONTENTS:
GLEWALLEN POJENAR	CHRISTIAN JADE A. BEATO ENGINEER (COS)	DRAFTED: Par
ENGINEER II DATE:	CALVIN D. CADATAL	REVIEWED:
CHIEF, PLANNING AND DESIGN DIVISION DATE:	GENE RYAN A. ALTEA	SUBMITTED:
ASSISTANT REGIONAL DIRECTOR DATE:	MELQUIADES H. STO. DOMINGO GERALD A. PACANAN, CESO	RECOMMENDED:
RÉGIONAL DIRECTOR	GERALD A. PACANAN, CESO III	APPROVED:
(3	0	SET NO. SHEET NO.
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SHEET CONTENT	SET NUMBER	SHEET NUMBER
	GENERAL	
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# SUMMARY OF QUANTITIES

Rem         Description         Qty         Unit         REMARKS           art A         A.11Field Office/Storage Facility         Qty         Unit         REMARKS           A.11Field Office/Storage Facility         2.00         mos.         mos.           A.12(8)         Provision of Combined Field Office, Laboratory and Living Quarters (Equipment and Appliances)         100         I.s.           A.12(8)         Provision of the Laboratory Testing Equipment. Appliances         100         I.s.           A.12(8)         Operation and Maintenance of Temporary Field Office. Laboratory and Living Quarters Building for the Engineer         2.00         mos.           A.12(8)         Operation and Maintenance of Temporary Field Office. Laboratory and Living Quarters Building for the Engineer         2.00         mos.           A.12(9)         Provision of Applicatory Special Service Vehicle for the Engineer         2.00         mos.           A.12(8)         Provision of Survey Personnel for the Assistance to the Engineer         2.00         mos.           A.12(9)         Provision of Fundance Applications and Service Special Program         5.00         mos.           A.13(1)         Provision of Program Survey Personnel for the Assistance to the Engineer         2.00         mos.           A.13(1)         Program Survey Personnel for the Application Survey Personnel for the Engineer		cu.m.	3,840.54	Fill and Backfill	705(1)
Description         Qty         Unit           A. 11Field Office/Storage Facility         200         mos.           Provision of Combined Field Office, Laboratory and Living Quarters Building for the Engineer (Rental Basis)         100         Ls.           Provision of Furniture/Fature, Equipment and Appliances for Field Office for the Engineer         100         Ls.           Provision of the Laboratory Testing Equipment, Apparatus and Publications for the Engineer         100         Ls.           Provision of Apparatus and Living Quarters Building for the Engineer         2.00         mos.           Operation and Maintenance of 1 emporary Field Office, Laboratory and Living Quarters Building for the Engineer         2.00         mos.           Provision of Applications for the Engineers         2.00         mos.           Provision of Bare Rental Basis         2.00         mos.           Operation and Maintenance of 4x2 Pick Up Type Service         2.00         mos.           Provision of Survey Personnel for the Assistance to the Engineer         2.00         mos.           Provision of Frogress Photographs         600.00         ea.           OTHER GENERAL REQUIREMENTS         100         Ls.           Medical Room and First Ald Facilities         2.00         ea.           Provision of Survey and Living Quarters         2.00         ea. <t< td=""><td></td><td>l.s.</td><td>1.00</td><td>Sho ring, Cribbing and Related Works, Cribbing/Cofferdamm</td><td>1702(5)a</td></t<>		l.s.	1.00	Sho ring, Cribbing and Related Works, Cribbing/Cofferdamm	1702(5)a
A .11Field Office/Storage Facility Provision of Combined Field Office, Laboratory and Living Quarters Building for the Engineer (Rental Basis) Provision of Furniture/Future, Equipment and Appliances for Field Office for the Engineer (Rental Basis) Provision of Furniture/Future, Equipment and Appliances for Field Office for the Engineer for Field Office for the Engineer for the		cu.m.	5,111.97	Structure Excavation	1702(1)a
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Description     Qty     Unit       A .11Field Office/Storage Facility     Qty     Unit       Provision of Combined Field Office, Laboratory and Living Quarters Building for the Engineer (Rental Basis)     2.00     mos.       Provision of Furniture/Future, Equipment and Appliances for Field Office for the Engineer     100     l.s.       Provision of the Laboratory Testing Equipment, Apparatus and Publications for the Engineer     100     l.s.       Provision and Maintenance of 1 emporary Field Office, Laboratory and Living Quarters Building for the Engineer     2.00     mos.       Operation and Maintenance of 1 emporary Field Office, Laboratory and Living Quarters Building for the Engineer     2.00     mos.       Operation and Maintenance of 4x2 Pick Up Type Service Vehicle for the Engineer on Bare Rental Basis     2.00     mos.       Operation and Maintenance of 4x2 Pick Up Type Service Vehicle for the Engineer     2.00     mos.       Provision of Survey Personnel for the Assistance to the Engineer     2.00     mos.       Provision of Frogress Photographs     5.00     ea.       OTHER GENERAL REQUIREMENTS     5.00     ea.       Medical Room and First And Facilities     2.00     ea.       Project Builboard/Signboard     2.00     ea.       Occupational Safety and Health Program     100     l.s.       Medical Room and First And Facilities     100     l.s.       Project B		cu.m.	2,632.35	Embankment from Borrow	104(2)a
Description  Qty  Unit  A.11Field Office/Storage Facility Provision of Combined Field Office, Laboratory and Living Quarters Building for the Engineer (Rental Basis) Provision of Furniture/Fixture, Equipment and Appliances for Field Office for the Engineer Provision of Hunditure/Fixture, Equipment and Appliances for Field Office for the Engineer  Provision of Hunditure/Fixture, Equipment, Apparatus and Publications for the Engineer  Operation and Maintenance of Temporary Field Office, Laboratory and Living Quarters Building for the Engineer  Provision of 4x2 Pick-up Type Service Vehicle for the Engineer on Bare Rental Basis  Operation and Maintenance of 4x2 Pick Up Type Service Vehicle for the Engineers  Provision of Survey Personnel for the Assistance to the Engineer  Provision of Progress Photographs  OTHER GENERAL REQUIREMENTS  Medical Room and First Aid Facilities  Project Billiboard/Signboard  Occupational Safety and Health Program  Mobilization and Demobilization  100 I.s.  Mobilization and Demobilization  100 I.s.				EARTHWORKS	PARTC
Description  Qty  Unit  A.11Field Office/Storage Facility Provision of Combined Fled Office Laboratory and Living Quarters Building for the Engineer (Rental Basis) Provision of Furniture/Fixture, Equipment and Appliances for Field Office for the Engineer Provision of the Laboratory Testing Equipment, Apparatus and Publications for the Engineer  Operation and Maintenance of Temporary Field Office, Laboratory and Living Quarters Building for the Engineer  Provision of 422 Pick-up Type Service Vehicle for the Engineer on Bare Rental Basis Operation and Maintenance of 422 Pick Up Type Service Vehicle for the Engineers  Provision of Florigress Photographs OTHER GENERAL REQUIREMENTS  Medical Room and Flist Aid Facilities  Project Billiboard/Signboard Occupational Safety and Health Program  Mobilization and Demobilization  Qty Unit  Qty Unit  A.11Field Office/Storage Facility 2.00 mos.  Is.  Quarters Building for the Engineer  2.00 mos.  Provision of 17 or gress Photographs  OTHER GENERAL REQUIREMENTS  Medical Room and Flist Aid Facilities  Project Billiboard/Signboard  Occupational Safety and Health Program  Mobilization and Demobilization  100 I.s.		l.s.	100	Detour/Access Road	B.15(1)
Description  Qty Unit  A.11Field Office/Storage Facility Provision of Combined Field Office Laboratory and Living Quarters Building for the Engineer (Rental Basis) Provision of Furniture/Fixture, Equipment and Appliances for Field Office for the Engineer Provision of the Laboratory Testing Equipment, Apparatus and Publications for the Engineer  Operation and Maintenance of Temporary Field Office, Laboratory and Living Quarters Building for the Engineer  Provision of 4x2 Pick-up Type Service Vehicle for the Engineer on Bare Rental Basis Operation and Maintenance of 4x2 Pick Up Type Service Vehicle for the Engineers  Provision of Survey Personnel for the Assistance to the Engineer  Provision of Progress Photo graphs OTHER GENERAL REQUIREMENTS  Medical Room and First Aid Facilities  Project Billiboard/Signboard Occupational Safety and Health Program  Qty Unit  Qty Unit  A.11Field Office/Laboratory and Living 2.00 mos.  Is.  Quarters  Disc.  Provision of Forgress Photo graphs OTHER GENERAL REQUIREMENTS  Medical Room and First Aid Facilities  Project Billiboard/Signboard Occupational Safety and Health Program  100 I.s.		l.s.	100	M o bilization and Demobilization	B.9
Description  Qty Unit  A.11Field Office/Storage Facility Provision of Combined Field Office, Laboratory and Living Quarters Building for the Engineer (Rental Basis) Provision of Furniture/Fixture, Equipment and Appliances for Field Office for the Engineer Provision of the Laboratory Testing Equipment, Apparatus and Publications for the Engineer Provision and Maintenance of Temporary Field Office, Laboratory and Living Quarters Building for the Engineer Provision of the Laboratory Testing Equipment, Apparatus and Publications for the Engineer  Provision of the Laboratory Field Office, Laboratory and Living Quarters Building for the Engineer  Provision of Ar2 Pick up Type Service Vehicle for the Engineer on Bare Rental Basis Operation and Maintenance of 4x2 Pick Up Type Service Vehicle for the Engineers  Provision of Survey Personnel for the Assistance to the Engineer  Provision of Progress Photographs OTHER GENERAL REQUIREMENTS  Medical Room and First Aid Facilities  Quarters Quarters Quo mos.  Qty Unit  100 I.s.  Mos.  Quarters Quo mos.  2.00 mos.  9.00 mos.  100 Lis.  OTHER GENERAL REQUIREMENTS  Medical Room and First Aid Facilities  100 I.s.		Is.	100	Occupational Safety and Health Program	B.7(2)
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Description  Qty  Unit  A.11Field Office/Storage Facility Provision of Combined Field Office, Laboratory and Living Quarters Building for the Engineer (Rental Basis) Provision of Furniture/Fixture, Equipment and Appliances for Field Office for the Engineer For Field Office for the Engineer Provision of the Laboratory Testing Equipment, Apparatus and Publications for the Engineer  Operation and Maintenance of Temporary Field Office, Laboratory and Living Quarters Building for the Engineer Provision of 4x2 Pick-up Type Service Vehicle for the Engineer on Bare Rental Basis Operation and Maintenance of 4x2 Pick Up Type Service Vehicle for the Engineers Provision of Survey Personnel for the Assistance to the Engineer Provision of Progress Photographs  OTHER GENERAL REQUIREMENTS		l.s.	100	Medical Room and First Aid Facilities	B.2
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Description  Qty Unit  A.11Field Office/Storage Facility Provision of Combined Field Office, Laboratory and Living Quarters Building for the Engineer (Rental Basis) Provision of Furniture/Fixture, Equipment and Appliances for Field Office for the Engineer Provision of the Laboratory Testing Equipment, Apparatus and Publications for the Engineer  Operation and Maintenance of Temporary Field Office, Laboratory and Living Quarters Building for the Engineer  Provision of 4x2 Pick-up Type Service Vehicle for the Engineer on Bare Rental Basis Operation and Maintenance of 4x2 Pick Up Type Service Vehicle for the Engineers  Provision of Survey Personnel for the Assistance to the Engineer		ea.	600.00	Provision of Progress Photographs	A.14(1)
Description  Qty Unit  A.11Field Office/Storage Facility Provision of Combined Fled Office, Laboratory and Living Quarters Building for the Engineer (Rental Basis) Provision of Furniture/Fixture, Equipment and Appliances for Field Office for the Engineer Provision of the Laboratory Testing Equipment, Apparatus and Publications for the Engineer Operation and Maintenance of Temporary Field Office, Laboratory and Living Quarters Building for the Engineer Provision of 4x2 Pick up Type Service Vehicle for the Engineers  Quantifications Qty Unit Qty Unit  Qty Unit  Qty Unit  2.00 mos.		mos.	2.00	Provision of Survey Personnel for the Assistance to the Engineer	A.13(3)
Provision of the Laboratory Testing Equipment, Apparatus for the Engineer (Pertails Building for the Engineer for Field Office for the Engineer Provision of the Laboratory Testing Equipment, Apparatus 100 I.s.  Operation and Maintenance of Temporary Field Office, Laboratory and Living Quarters Building for the Engineer Provision of 4x2 Pick-up Type Service Vehiole for the 200 mos.		mos.	2.00	Operation and Maintenance of 4x2 Pick Up Type Service Vehicle for the Engineers	A.12(6)
Description  Qty Unit  A.11Field Office/Storage Facility Provision of Combined Field Office, Laboratory and Living Quarters Building for the Engineer (Rental Basis) Provision of Furniture/Fixture, Equipment and Appliances for Field Office for the Engineer Provision of the Laboratory Testing Equipment, Apparatus and Publications for the Engineer  Operation and Maintenance of Temporary Field Office, Laboratory and Living Quarters Building for the Engineer  2.00 mos.		mos.	2.00	Provision of 4x2 Pick-up Type Service Vehicle for the Engineer on Bare Rental Basis	A.12(4)
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Description  Qty Unit  A.11Field Office/Storage Facility Provision of Combined Field Office, Laboratory and Living Quarters Building for the Engineer (Rental Basis)  2.00 mos.		ls.	100	Provision of Furniture/Fixture, Equipment and Appliances for Field Office for the Engineer	A.1%11)
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Description Qty Unit QUANTIT				A.11Field Office/Storage Facility	Part A
Description	REMARKS	Unit	Qty		
	QUANTITY	0		Description	Item

птү	Item	Description			QUANTITY
REMARKS			Qty	Unit	REMARKS
	Part I-B	Bank and Slope Protection Works			
	506(1)	Stone M asonry	2,144.00	cu.m.	
	508	Handlaid Rock Embankment	5,285,88	cu.m.	
	Part III	Civil, Mechanical, Electrical and Sanitary/Plaumbing Works	bing Works		
	900(1)c2	Structural Concrete Class "A" (Footing & lean Concrete)	502.08	cu.m.	
	900(1)c4	Structural Concrete Class "A" (column)	27135	cu.m.	
	900(1)c5	Structural Concrete Class "A" (Slab, Parapet & Stairs)	662.79	cu.m.	
	900(1)c6	Structural Concrete "A" (Beam)	128.94	cu.m.	
	902(1)a	Reinforcing Steelbar (Deformed) Grade 40	211,682.51	kg.	
	903(2)	Forms and Falseworks	9,674.25	cu.m.	
	Part C	Finishings and Other Civil Works			
	17 16(6)a	Sheet Piles, Furnished	2,025.00	lm.	
	76(2)	Sheet Piles, Driven	1,913.00	l.m.	
	75(8)	Geotextile	36.00	bags	
			200		
	1027(1)	Cement plaster finish	8,514.69	sq.m.	
	1032(1)a	Painting Works, Masonry/Concrete	8,334.79	sq.m.	
	1051(6)	Railings	2,663.48	lm	
	624(8)	Solar LED Street Light (Integrated Street Light)	244.00	ea.	

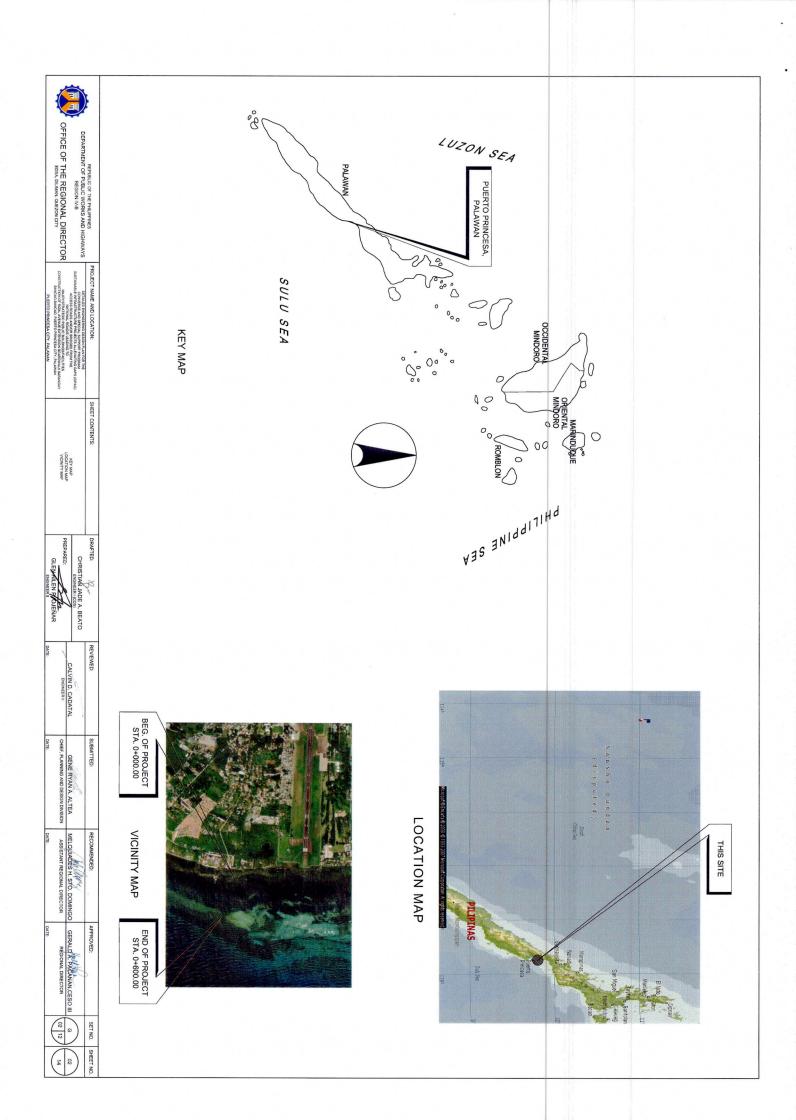OFFICE OF THE REGIONAL DIRECTOR	DEPARTMENT OF PUBLIC WORKS AND HIGHWAYS REGION IV-B	REPUBLIC OF THE PHILIPPINES
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PROJECTI ALME AND LOCATIONS  SHEET CONTENTS:  SHEATO CONTENTS:  SHEATO CONTENTS:  SHEATO CALVIN D. CADATAL  CONTENTS:  CONTENTS:  CONTENTS:  SHEATO CALVIN D. CADATAL  CONTENTS:	RECTOR	HIGHWAYS	
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REVENED: SUBMITED: RECOMMEDICE: APPROVED: APPROVED: SET NO.  THRISTIMAL LODGE A, BEATTO  CALVIN D. CADATAL GENE RYAN A ALTEA MELOULOGES H. STO. DOMINGO GERALD R. PACANAN CESO III  COLETATEN POLERAR  CHEF PLANNING AND DESIGN DYSIGN ASSISTANT RECOMAL DIRECTOR REGIONAL DIRECTOR  OLEF PLANNING AND DESIGN DYSIGN ASSISTANT RECOMAL DIRECTOR COLUMN DIRECTOR  OLEF PLANNING AND DESIGN DYSIGN DY	SUMMERT OF CLIPATITIES	OBJECT OF OBJECT	SHEET CONTENTS:
SUBMITTED  RECOMMENDED  RECOMMENDED  APPROVED  APPROVED  APPROVED  SET NO.  RECOMMENDED  APPROVED  APPROVED  SET NO.  SE	- <del>*</del> V	HRISTI	DRAFTED:
MITED RECOMMENDED APROVED SET NO.  GENE RYAN A ALTEA MELQUIADES H. STO. DOMINGO GERALD A PROMANCESO III GO T2  F. PANNING AND DESCRIPTION ASSISTANT REGIONAL DESCRIPTION OATE  OATE  APROVED  SET NO.	Ħ \	CALVIN D. CADATAL	REVIEWED:
MAPROVED:  APPROVED:  SET NO.  APPROVED:  SET NO.  APPROVED:  SET NO.  SET NO.  APPROVED:  SET NO.	CHIEF, PLANNING AND DESIGN DIVISION DATE:	GENE RYAN A. ALTEA	SUBMITTED:
PACAMAN CESO III GOMAL DIRECTOR 03 12	ASSISTANT REGIONAL DIRECTOR DATE:		RECOMMENDED:
SET NO. SHEET NO.  G 03 12 03 14		GERALD A. PACANAN,CESO III	APPROVED:
SHEET NO.	03 12	6	SET NO.
	4	3	SHEET NO.

SET NO. SHEET NO.

### GENERAL NOTES: 3.0 FOUNDATION 2.0 DESIGN CRITERIA 1.0 STANDARDS AND REFERENCES 31.1 MOJES IN THE ACTIMAL LOCATION OF THE STRUCTURE IS LESS THAN THE ASSUMED DISNAME FROM THE SESSIME DISNAME FROM THE DESCOR BREEFAU OF DESCORE REVISION OF THE DESCORE REPUBLICATION OF THE DESCORE REPUBLICATION OF THE PHALIPPINES OR PHAYOLOGS SESSIME OSCURGE MAP PROPUBLED IN THE NATION STRUCTURAL CODE OF THE PHALIPPINES OR PHAYOLOGS SESSIME OSCURGE MAP OF DOMINION OF THE STRUCTURAL CODE OF THE STRUCTURAL CODE CONSULCTURE OF THE STRUCTURAL SECONDALICATION OF DESCORE ACTIVATION OF THE DIRECTOR BUREAU OF DESCORE DAY OF THE STOUND LIES THAN THE ASSUMED. 98 KPW, NOTIFY THE DIRECTOR BUREAU OF DESCORE TOR PROPER REVISION OF FOUNDATION. 3.1.4. NO FOOTING SHALL REST ON FILL. 3.1.6. SOIL BEARING CAPACITY SHALL BE INCREASED BY 33 WHEN IN COMBINATION WITH SEISMIC OR WIND LOAD. 2.2 3.4 WHERE LOOSE SOFT MATERIAL IS ENCOUNTERED AT DEPTH OF EMBEDMENT INDICATED, EXCAVATE TO FIRM LAYER AND REPLACE LOOSE MATERIALS UNDERNIEATH THE FOOTING WITHIN 3.3 BACK FILL SHALL BE PLACED IN LAYER AND EACH LAYER SHALL BE 200 mm THICK AND SHALL BE COMPACTED TO 95 MAXIMUM DRY DENSITY. $3.2\,$ ALL COLUMN FOOTINGS & TIE BEAMS SHALL REST ON 100 mm. THICK WELL COMPACTED GRAVEL BASE COURSE. 3.1 ASSUMED SOIL BEARING CAPACITY SHALL BE 96 KPa (2,000 PSF) 1.1 NATIONAL STRUCTURE CODE OF THE PHILIPPINES (N.S.C.P.) VOL. 1, 6th EDITION, 2010 THE FOLLOWING SHALL GOVERN THE DESIGN, FABRICATION & CONSTRUCTION OF THE PROJECT. THE FOOTING AREA PLUS //2 DEPTH OF SOFT MATERIALS ON ALL SIDES WITH SELECT GRANULAR BACKFILL. COMPACT SELECT GRANULAR BACKFILL TO 95 MAXIMUM DRY DENSITY. DESIGN STRESSES A. CONCRETE COMPRESSIVE STRENGTH @ 28 DAYS NON- LOAD BEARING CHB WALLS F. WELDS - USED E - 60 xx ELECTRODE G. STRUCTURAL BOLTS, ASTM - A307 a. Ft = 96.60 MPa (14,000 psi) C. WND LOAD (NSCP 2010) BASIC WIND VELOCITY, V = 250 KPH P = qh (GCqh) (GCqh) (DESIGN WIND PRESSURE) P = qh (GCqh) = LALCOTH PRESSURE COEPFICIENT GCpi = NTERNAL PRESSURE COEFFICIENT GCpi = INTERNAL PRESSURE COEFFICIENT COLD FORMED LIGHT CAGE SHAPES E. MASONRY UNIT (CHB) D. PURLIN a. FOR BARS 10 mm Ø AND GREATER C. STRUCTURAL STEEL, ASTM - A36 FOR TRUSSES, BRACING, & STRUTS B. REINFORCING BARS OFFICE OF THE REGIONAL DIRECTOR EDSA DILIMAN, QUEZON CITY B. LIVE LOAD D. SEISMIC LOAD (NSCP 2010) REPUBLIC OF THE PHILIPPINES DEPARTMENT OF PUBLIC WORKS AND HIGHWAYS REGION IV-B TOILETS CORRIDORS ABOVE, STAIRS CORRIDORS ON GROUND 150 mm THK. CHB WALL 100 mm THK. CHB WALL CONCRETE WHERE: Vmax = 2.50 Cal R W < 찍Ω ♥ CLASSROOMS, LABORATORY (DESIGN BASE SHEAR) SEISMIC COEFFICIENT $C_{V}=0.44~N_{V}$ $C_{O}=0.64~N_{V}$ NEAR SOURCE FACTOR (10 km) $N_{V}=1.2$ WHERE: C = NUMERICAL COEFFICIENT h = BUILDING HEIGHT I = IMPORTANT FACTOR = 1.50 R = NUMERICAL FACTOR = 8.50 Z = SEISMIC ZONE = 0.40 (ZONE 4) S = SOIL TYPE = D W = TOTAL DEAD LOAD T = NATURAL PERIOD = C (h) Vmin = 0.11 CaW b. Fv = 69 MPa (10,000 psi) -1.00 KPa -1.90 KPa -2.40 KPa -3.80 KPa 4.80 KPa -23.56 kN/m³ -76.93 kN/m³ -2.73 kPa -2.11 kPa fm' = 3.45 MPa (500 psi) fy = 248 MPa (36,000 psi) ty = 248 MPa (36,000 psi) tc' = 20.7 MPa (3,000 psi) Na = 1.0 fy = 275 MPa (40,000 psi) PROJECT NAME AND LOCATION: 4.0 MATERIALS SHEET CONTENTS: 4.2 COLUMNS; LP SPLICES SHALL BE MADE WITHIN THE CENTER HALF OF HEIGHT AND THE SELICE SHALL NOT BELLESS THAN 30 COLUMNS; LP SPLICES SHALL BE MADE WITHIN THE CENTER HAVE DIFFICED FROM THE LIBE OF A PROVIDED MECHANICAL DEPLICES MAY BE FERMITTED PROVIDED NOT MORE THAN ALTERWAITE DAYS. ARE WELDED OR SPLICED AT ANY LEVEL, AND THE MINIMAN VERTICAL DISTANCE BETWEEN TWO ALTERWAITE DAYS. B. BEAMS FRAMING TO COLUMNS: TOP BARS SHALL BE SPLICED AT MID SPAN AND BOTTOM BARS SHALL NOT BE SPLICED WITHIN THE COLUMN OR WITHIN A DISTANCE OF TWICE THE MEMBER DEPTH FROM THE PACE OF THE COLUMN, THE SPLICED LEWITH SHALL NOT BE LESS THAN 1:4 TIMES THE DEVELOPMENT LENGTH (La) IN CA 2.8 BELOW BUT NOT LESS THAN 6:40 mm. 5.0 CONSTRUCTION JOINT 5.2 UNLESS SHOWN OTHERWISE, SLAB ON GRADE SHALL HAVE CONTROL JOINTS SPACED AT 6000 mm MAXIMUM CENTER TO CENTER. CHB WALLS; VERTICAL BARS SHALL BE SPLICED AT THE TOP OF WALL FOOTINGS OR FOOTING-TIE BEAMS AND AT THE BOTTOM OF REINFORCED CONCRETE LINTEL BEAMS OR BEAMS. 5.3 BEAMS CONSTRUCTION JOINT SHALL BE LOCATED WITHIN THE MIDDLE THIRD OF THE SPAN, IT SHALL BE PROVIDED WITH 3 EXTRA STIRRUPS @ 75 mm O.C. ON EACH SIDE OF THE JOINT. 5.1 CONSTRUCTION JOINT NOT INDICATED ON THE PLANS SHALL BE MADE SO AS TO LEAST IMPAIR THE STRENGTH OF THE STRUCTURE AND SHALL BE SUBJECT TO THE APPROVAL OF THE ENGINEER EXCEPT SLAB ON GRADE. THE SUPPORT. INTERMEDIATE BEAMS; TOP BARS SHALL BE SPLICED AT MID SPAN, AND BOTTOM BARS AT ADJACENT BAR SPLICES 4.2.7 426 UNLESS OTHERWISE INDICATED: ALL BEAMS TERMINATING AT A COLUMN SHALL HAVE TOP AND BOTTOM BARS EXTENDING TO THE FAR FACE OF THE COLUMN, TERMINATING IN A STANDARD 90 HOOK LENGTH OF ANCHORAGE SHALL NOT BE LESS THAN 800 mm. 4.1.1 CONCRETE COVER OVER REINFORCING BARS SHALL BE AS FOLLOWS: A FROTINGS, FOOTING-THE BEAMS (CAST AGAINST EARTH) B. BEAMS AND COLUMNS (TO STIRRUPS MAD TIES) C. WALLS, SIDE OF FOOTING-THE BEAMS (CAST AGAINST FORM) CONCRETE 4.2.8 DEVELOPMENT LENGTH (Ld) OF REINFORCING BARS SHALL BE AS FOLLOWS 4.2.4 UNLESS OTHERWISE INDICATED, SPLICING OR REINFORCEMENT SHALL BE IN ACCORDANCE WITH AC1-318M, EXCEPT THAT THE MINIMUM LAP SPLICE SHALL 4.2.5 UNLESS SHOWN OTHERWISE ON PLANS, SPLICES SHALL BE AS FOLLOWS: 4.2.2 ALL REINFORCING BARS SHALL BE ACCURATELY AND SECURELY PLACED BEFORE POURING CONCRETE OR APPLYING MORTAR OR GROUT. REINFORCING BARS 4.1.2 4.2.1 ALL REINFORCING BARS SHALL BE CLEAN OF RUST, GREASE OR OTHER MATERIALS THAT WILL IMPAIR BOND. 4.2.3 LAPPED SPLICES SHALL BE STAGGERED WHERE POSSIBLE. SHOP DRAWINGS FOR REINFORCEMENT SHALL BE SUBMITTED FOR APPROVAL OF THE ENGINEER PRIOR TO FABRICATION AND INSTALLATION. GENERAL NOTES (1/3) BE 40 BAR DIAMETER BUT NOT LESS THAN 600 mm. BEFORE CONCRETE IS POURED, CHECK WITH ALL TRADES TO ENSURE PROPER PLACEMENT OF ALL OPENINGS, SLEEVES, CURBS, CONDUITS, ETC., RELATING TO SIZE OF REBARS 10 mm 12 mm 16 mm 20 mm 3 EXTRA STIRRUPS AT 75 mm O.C CONSTRUCTION JOINT PREPARED DRAFTED DEVELOPMENT LENGTH 170 mm 220 mm 270 mm 380 mm BEAM CONST. JOINT CHRISTIAN GLEWAILEN POJEÑAR Ī JADE A. BEATO 3 EXTRA STIRRUPS \_AT 75 mm O.C (DO NOT INTERRUPT) REVIEWED: CALVIN D. CADATAI 75 mm 40 mm 40 mm 20 mm GENE RYAN A. ALTEA CHIEF, PLANNING AND DESIGN DIVISION SUBMITTED: 2.180° HOOKS MAY BE SUBSTITUTED FOR 90° HOOKS. ALL BENDS SHOWN IN DETAILS SCHEDULES SHALL BE STANDARD HOOK OTHERWISE NOTED. 10 mm Ø THRU 25 mm Ø AS PER COLUMN SCHED. BAR SIZE BEAM RE-BAR TERMINATION BEND MELQUIADES H. STO. DOMINGO ASSISTANT REGIONAL DIRECTOR RECOMMENDED: TRANSVERSE BEAM REBARS INTERIOR COLUMN TERMINATION BEND SCALE 1:50 MTS SCALE 1:10 MTS TYPICAL REINFORCEMENT DETAIL 500( MIN MUM ) 90 ° HOOK 180 ° HOOK 6d 4d GERALD A. PACANAN, CESO III REGIONAL DIRECTOR APPROVED: WIRE TIGHTLY TOGETHER-AS PER COLUMN SCHEDULE INTERIOR COLUMN REBARS TERMINATION BEND (MIN MUM COLUMN REBARS BEAM BEAM REBARS SET NO. LAP SPLICE OFFSET SHEET NO.

### DRAINAGE PIPE / WEEP HOLE

PHENOMENON LEADS TO THE COLLAPSE OF THE REVETMENT IN ORDER TO PREVENT THE OUTFLOW OF OUT OF FINE BACKFILL MATERIALS THROUGH THE JOINTS OF REVETMENT AND WEEP HOLES. THIS ONE OF THE MAIN CAUSES OF CAVING IN OF SOIL PARTICLES BEHIND THE REVETMENT IS THE FLOWING DRAINAGE PIPES/WEEP HOLES SHOULD BE DESIGNED AND PROVIDED FOR BOTH TYPES OF REVETMEN. GEO-TEXTILE IS PLACED BETWEEN THE REVETMENT AND ORIGINAL GROUND TO PREVENT THE STAGGEREDLY PLACED IN THE HORIZONTAL DIRECTION AND SPACED 2 METERS CENTER TO CENTER. HOLES SHOULD BE PROVIDED IN THE REVETMENT USING 50~75 MM DIAMETER PVC DRAINPIPES, SUBSIDING FLOODWATER AND GROUNDWATER STAGES IS SIGNIFICANTLY HIGH, RESIDUAL HYDRAULIC BEHIND THE REVETMENT WITHOUT DRAINAGE PIPES/WEEP HOLES. IF THE DISPARITY BETWEEN THE OF FLOODWATER IN THE RIVER IS USUALLY GREATER THAN THE RECESSION OF GROUNDWATER LEVEL RIVER IS ALMOST COINCIDING WITH THE RISE OF GROUNDWATER BEHIND THE REVETMENT ESPECIALLY FOR DIKED AND NON-DIKED RIVERS. DURING FLOOD TIMES, THE RISE OF FLOOD WATER LEVEL IN THE THESE FINE MATERIALS. MOREOVER, PERVIOUS MATERIALS CONSISTING OF CRUSHED GRAVEL OR PRESSURE EXISTS AT BACK OF THE REVETMENT WHICH MIGHT BECOME HIGHER (FIGURE 2.6). WEEP WHEN THE GROUND HAS BEEN ALREADY SATURATED. AFTER THE FLOODS, THE RATE OF SUBSIDENCE

## STRENGTHENING UPPER AND LOWER ENDS

INSTALLED JUST ABOVE THE ORDINARY WATER LEVEL

OUTFLOW OF THE BANK MATERIALS THROUGH THE WEEP HOLES. THE LOWEST WEEP HOLES SHALL BE

COLLAPSE. IN CONSTRUCTING A PIECE-MEAL PROJECT, TEMPORARY PROTECTION WORKS (E.G., BOULDER REVETMENT UP TO THE BACKFILL MATERIAL. THE THICKNESS OF THE END PROTECTION SHALL BE MORE STRUCTURE TYPE REVETMENTS. THE END PROTECTION SHALL COVER THE EXTENT OF THE COVERING WORK AND GABION) SHALL BE PROVIDED. THE END PROTECTION WORK IS INDISPENSABLE TO THE RIGID MAKE THESE PORTIONS OF THE STRUCTURE BECOME WEAK AND PRONE TO DAMAGE OR POSSIBLE AND CREST WORK. THE THICKNESS OF THE END PROTECTION WORK SHALL BE FROM THE SURFACE OF GENERALLY, THE END POINTS OF REVETMENT ARE ALWAYS SUBJECTED TO EXTERNAL FORCES, WHICH

# **B. MATERIALS SPECIFICATION & CONST. METHODS**

ON THE PREPARED FOUNDATION BED, IN ACCORDANCE WITH THIS SPECIFICATION AND IN CONFORMITY WITH THE AIRPORTS 2013 EDITION ALL WORKS SHALL COMPLY WITH ITEM 506 OF THE STANDARD SPECIFICATION FOR HIGHWAYS, BRIDGES AND LINES, GRADES, SECTIONS, AND DIMENSIONS SHOWN ON THE PLANS OR AS ORDERED IN WRITING BY THE ENGINEER RETAINING WALLS AT THE TOES OF SLOPES, AND AT OTHER PLACES CALLED FOR ON THE PLANS, CONSTRUCTED THIS ITEM SHALL CONSIST OF STONE MASONRY IN MINOR STRUCTURES, IN HEADWALLS FOR CULVERTS, IN

### SHEET PILES

STANDARD SPECIFICATION FOR HIGHWAYS, BRIDGES AND AIRPORTS. THIS SHALL CONSIST OF FURNISHING, DRIVING AND CUTTING OFF OF SHEET PILING COVERED BY THE 2013

PAINTING SHALL CONFORM TO THE REQUIREMENTS FOR ITEM 411, PAINT, SUBSECTION 411.3.6.2, PAINTING PROVISIONS, AND SHALL CONFORM TO THE REQUIREMENT OF ITEM 400, PILING, SUBSECTION 400.2.7, SHEET PILES, STEEL SHEET PILES SHALL BE THE TYPE, WEIGHT AND SECTION MODULUS INDICATED ON THE PLANS OR SPECIAL

ALL CONCRETE MIXTURE SHALL BE CLASS "A" (1:2:4 MIX) FOR R.C. REVETMENT

## WHEN CONCRETING UNDER WATER TO COMPENSATE FOR THE LOSS OF STRENGTH DUE TO WATER INFILTRATION THE CEMENT CONTENT OF THE DESIGN MIX SHALL BE ADJUSTED IN ACCORDANCE WITH THE AASHTO PROVISIONS

REINFORCING STEEL SHALL CONFORM TO AASHTO M31 (ASTM A615), GRADE 40 AND 60, DEFORMED WITH MINIMUM YIELD STRENGTH AS DESCRIBED BELOW:

### REPUBLIC OF THE PHILIPPINES DEPARTMENT OF PUBLIC WORKS AND HIGHWAYS REGION IV-B PROJECT NAME AND LOCATION:

OFFICE OF THE REGIONAL DIRECTOR
EDSA DILMAN, QUEZON CITY

UERTO PRINCESA CITY, PALAWAN

PREPAR	GENERAL NOTES (2/3)	GAY
		PAG)
DRAFTE	SHEET CONTENTS:	

### GENERAL NOTES

60	40	REBAR GRADE
414 (60 Ksi)	276 (40 Ksi)	YIELD STRENGTH fy (MPa)
20mmØ & ABOVE	16mmØ & BELOW, UNLESS OTHERWISE NOTED	SIZE (mm)

REINFORCING STEEL SHALL BE FREE OF MILL SCALES, OIL OR ANY SUBSTANCES WHICH WILL WEAKEN THE

6

BOND WITH CONCRETE

REINFORCING STEEL SHALL BE WELDABLE TYPE. WELDING REINFORCING STEEL SHALL CONFORM TO ANSI/ AWS D1.4.

THE LEAST DIMENSION SHOULD NOT CONSTITUTE MORE THAN 10 PERCENT OF THE TOTAL. STONES SHOULD BE WELL BLENDED. THE STONES WITH THE LARGEST DIMENSION, GRATER THAN THREE TIMES

MATERIALS SHOULD BE INERT TO CHEMICAL AND BIOLOGICAL DEGRADATION IN SEA WATER

STONE) FILTER LAYER WHICH MEETS THE STATED FILTER DESIGN CRITERIA. THE BEDDING LAYER IS PLACED ON A FILTER CLOTH OR A COARSE GRAVEL (OR CRUSHED FOUNDATION MATERIAL. QUARRY SPALLS RANGING IN SIZE FROM 0.45 KG TO 23 KG WILL GENERALLY SUFFICE IF LESS THAN OR EQUAL TO FIVE TIMES THE DIAMETER EXCEEDED BY THE COARSEST 15 PERCENT OF THE (FOUNDATION); i.e, THE DIAMETER EXCEEDED BY THE COARSEST 85 PERCENT OF THE FILTER MATERIAL MUST BE GRADATION REQUIREMENTS OF THE BEDDING LAYER OF FILTER BLANKET SHALL BE 015 (FILTER)< 5 085

THE FOLLOWING STANDARD TESTS SHALL BE CONDUCTED TO ESTABLISH MATERIAL DURABILITY:

APPARENT SPECIFIC GRAVITY AND ABSORPTION TEST HARDNESS TEST TOUGHNESS TEST ABRASION TEST ASTM C-127 OR EQUIVALENT ASTM C-235 OR EQUIVALENT ASTM C-170 OR EQUIVALENT ASTM C-535 OR EQUIVALENT

### 6. GEOTEXTILE

CHEMICAL AND BACTERIOLOGICAL ATTACK. PLACEMENT AND MATERIAL STRENGTH IS AS SPECIFIED IN THE SECTION EXTREMELY HIGH STRENGTH AT LOW STRAIN. IT MUST HAVE A GOOD WATER PERMEABILITY AND IS RESISTANT TO CONDITION (SEE DRAWINGS AND SPECIFICATIONS). THE GEOTEXTILES TO BE USED SHALL HAVE HIGH MODULUS AND ENGINEERED TO PROVIDE EXCELLENT ROBUSTNESS, UV PROTECTION AND DURABILITY IN MARINE AND HYDRAULIC GEOTEXTILES SHALL BE WOVEN AND/ OR NONWOVEN FABRIC AS SPECIFIED IN THE DRAWINGS SPECIALLY

### 7. GEOTUBES

FILLING AND DURING OPERATIONAL LIFE. THE TENSILE STRENGTH IS AS SPECIFIED ON THE SECTION DRAWINGS. MANUFACTURER SHALL CERTIFY COMPLIANCE OF THESE REQUIREMENTS. GEOTUBES MANUFACTURED FROM POLYESTER FIBER SHALL NOT BE ACCEPTED. THE GEOTUBE SUPPLIER/ COMBINED WITH HIGH CAPACITY SEAMS TO PRODUCE TUBULAR CONTAINERS WITH ENSURED INTEGRITY DURING GEOTUBES TO BE USED SHALL BE MANUFACTURED FROM HIGH MODULUS POLYPROPYLENE ENGINEERED FABRICS

PERISHABLE MATERIAL, TOXIC, COMBUSTIBLE OR DANGEROUS MATERIAL, METAL, RUBBER OR OTHER UNSUITABLE THE FILL MATERIAL SHALL NOT CONTAIN MATERIALS SUSCEPTIBLE TO VOLUME CHANGE (i.e. TIME OF FILLING IS CAPABLE OF FULFILLING THE SPECIFIED REQUIREMENTS TO PROVIDE MASS AND INTEGRITY THE SAND INFILL MATERIAL SHALL CONSIST OF NATURALLY OCCURRING OR PROCESSED MATERIAL WHICH AT THE MARINE MUD, SWELLING CLAYS AND COLLAPSIBLE SOILS), PEAT, VEGETATION, TIMBER, ORGANIC, SOLUBLE OR

	Ec /2/21		
GLEWALEN POJEÑAR		CHRISTIAN JADE A. BEATO ENGINEERI (COS)	DRAFTED:
ENGINEER	CALVIN D. CADATAL		REVIEWED:
CHIEF, PLANNING AND DESIGN DIVISION ASSISTANT REGIONAL DIRECTO	GENE KTAN A. ALIEA		SUBMITTED:
Ä	MELGUIADES T. SEC. DOMINGO	Millians	RECOMMENDED:
REGIONAL DIRECTOR	GERALU A. PACANAN, CESO III		APPROVED:
05 12	0	5)	SET NO.
14	00		SET NO. SHEET NO.

### **CODES AND REFERENCES** CONSTRUCTION 3. REINFORCED CONCRETE 2. SETTING OUT 3.1 CAST IN PLACE CONCRETE SHALL BE CLASS "A" 3.2 CONCRETE MIX AND PLACING THE SETTING OUT AND THE ELEVATIONS OF THE DIFFERENT COMPONENTS OF THE STRUCTURE SHALL BE APPROVED BY THE ENGINEER PRIOR TO THE START OF ANY CONSTRUCTION WORK. 1.3 ALL STATIONING ARE IN KILOMETER PLUS METER AND 1.2 ALL DIMENSION SHOWN ARE IN MILLIMETERS UNLESS 1.1 SECTION, DIMENSIONS AND DISTANCES SHALL NOT BE 2. DPWH STANDARD SPECIFICATIONS FOR HIGHWAYS. BRIDGES AND AIRPORTS - VOL. II, 2013 ED 1. DPWH DESIGN GUIDELINES, CRITERIA AND STANDARDS (DGCS) - VOL. III, 2015 ED. FOR HIGHWAYS, BRIDGES AND AIRPORTS OR MODIFIED BY SPECIAL CONSTRUCTION SHALL COMPLY WITH 1995 DPWH STANDARD SPECIFICATION THE DESIGN OF BRIDGES IS BASED ON THE CONSTRUCTION FOR THE PROJECT. HARBORS, FLOOD CONTROL AND DRAINAGE STRUCTURES AND WATER SUPPLY SYSTEMS) VOL. III, 3. DPWH STANDARD SPECIFICATIONS FOR PUBLIC WORKS STRUCTURES (BUILDINGS, PORTS AND SEQUENCE MUST BE APPROVED BY THE ENGINEEER. SEQUENCE SHOWN IN THE DRAWING. ANY VARIATION FROM THE SHALL BE READ IN CONJUNCTION WITH THE TECHNICAL SPECIFICATIONS THESE NOTES ARE PROVIDED FOR QUICK REFERENCE ONLY AND (2) EXCEPT RAILINGS WHICH SHALL BE CLASS "C" UNLESS OTHERWISE NOTED ON THE PLANS. ALL EXPOSED EDGES SHALL BE CHAMPERED 25mm EXCEPT RAILINGS AND RE-ENTRANT ANGLES WHICH SHALL BE CHAMPERED AND FILLETED 13mm RESPECTIVELY. SCALED FOR CONSTRUCTION PURPOSES. THE INDICATED DIMENSION SHALL GOVERN UNLESS OTHERWISE SPECIFIED. REPUBLIC OF THE PHILIPPINES DEPARTMENT OF PUBLIC WORKS AND HIGHWAYS REGION IV-B ELEVATION IN METER. OTHERWISE NOTED POURING SEQUENCES FOR ALL CONCRETE WORKS. THE CONTRACTOR SHALL SUBMIT TO THE ENGINEER FOR APPROVAL FOR CONCRETE DEPOSITED AGAINST THE GROUND. LEAN CONCRETE WITH A MINIMUM THICKNESS OF 50mm SHALL LAID FIRST BEFORE CONCRETE SHALL BE DEPOSITED, VIBRATED AND CURED IN DESIGN OF CONCRETE MIX SHALL MEET THE DESIGN CONCRETE INSTALLING THE REINFORCEMENT, THIS LEAN CONCRETE SHALL NOT BE ACCORDANCE WITH THE SPECIFICATIONS. STRENGTH GIVEN UNDER ITEM 1 OF MATERIALS. CONSIDERED IN MEASURING THE STRUCTURAL DEPTH OF CONCRETE PROJECT NAME AND LOCATION: CONTRICTORY DEVOKEDING DESCORE AN TOTAL THE CONTRICT PROCESSOR AND SECUL SHOOT PROCESSOR PROCESSOR AND SECUL SHOOT PROCESSOR PROCESSOR AND SECUL SHOOT PROCESSOR P 3 (6) (5) (8) HOOKS AND BENDS SHEET CONTENTS: NOT MORE THAN 50% OF THE BARS AT ANY ONE SECTION SHALL BE SPLICED. CRANKED SPLICES MAXIMUM SIZE OF COARSE AGGREGATE. THE CLEAR DISTANCE BETWEEN LAYERS SHALL NOT BE LESS THAN 25mm NOR ONE BAR DIAMETER. THE BETWEEN PARALLEL BARS IN LAYER SHALL NOT BE LESS THAN 1.5 TIMES THE NOMINAL DIAMETER OF THE BAR NOR LESS THAN 1.5 TIMES THE UNLESS OTHERWISE SHOWN ON DRAWINGS. THE CLEAR DISTANCE BARS IN THE UPPER LAYER SHALL BE PLACED DIRECTLY ABOVE THOSE IN THE BOTTOM LAYER 3.3 BAR BENDING, SPLICING AND PLACING DIMENSIONS OF 90 - DEGREE AND 180 - DEGREE HOOKS PIN DIAMETER: (3) (2) 3 DIMENSIONS FOR STIRRUPS AND TIE HOOKS PIN DIAMETER: 90° НООК BAR SPLICING NOT INDICATED ON DRAWINGS SHALL BE SUBJECT TO THE APPROVAL OF THE ENGINEER. WELDED SPLICES, IF APPROVED BY THE ENGINEER, SHALL DEVELOP IN TENSION AT LEAST 125% OF THE SPECIFIED YIELD STRENGTH OF THE SHALL NOT BE FIELD BENT UNLESS PERMITTED BY THE ENGINEER. BARS SHALL BE BENT COLD. BARS PARTIALLY EMBEDDED IN CONCRETE THE CONTRACTOR SHALL SUBMIT TO THE ENGINEER FOR APPROVAL INSTALLATION OF ALL REINFORCING BARS. DRAWINGS INDICATING THE BENDING, CUTTING, SPLICING AND D = 6d FOR Ø10 THRU Ø25 D = 8d FOR Ø28, Ø32 AND Ø36 D = 6d FOR Ø10 THRU Ø25 D = 8d FOR Ø28, Ø32 AND Ø36 MAX = 15 d 12 d CHRISTIAN JADE A. BEATO 180° HOOK DIAMETER = 4d OR 30 d MAX REVIEWED: CALVIN D. CADATA 3.4 CONCRETE COVER TO REINFORCEMENT (2) THE INTERFACE BETWEEN THE FIRST AND SECOND POUR CONCRETES SHALL BE ROUGHENED OR AS (1) THE POSITION AND FORM OF ANY CONSTRUCTION JOINT SHALL BE AS SHOWN ON DRAWINGS b. SALT WATER. a. FRESH WATER... WITH AN THE FACE OF ANY BAR SHALL BE 40mm. BARS AND THE MINIMUM 2. EMBEDDED BOULDERS FOR THE FACING SHOULD NOT BE LESS THAN THIRTY ( 30mm ) 1. ALL CONCRETE MIXTURE SHOULD BE CLASS \*B \* (1: 2.5:5) MIX 3.4 CONSTRUCTION JOINT RUBBLE CONCRETE SPECIFICATION SHALL BE 40mm. FROM THE SURFACE OF THE CONCRETE TO THE FACE OF ANY BAR TO THE CENTER OF BARS AND THE MINIMUN COVERING MEASURED UNLESS OTHERWISE NOTED, ALL BAR DIMENSIONS ARE REFERED 3.3 CONCRETE COVER TO REINFORCEMENT FOR SUBSTRUCTURE, COVERING SHALL BE APART AND SHALL BE AT LEAST THIRTY ( 30mm ) BELOW THE OUTSIDE 1. PERMANENTLY EXPOSED TO EARTH AND WEATHER FOR SUBSTRUCTURE, COVERING SHALL BE b. SALT WATER. a. FRESH WATER. 1. PERMANENTLY EXPOSED TO EARTH AND WEATHER UNLESS OTHERWISE NOTED, ALL DIMENSIONS ARE REFERRED TO THE CENTER OF AMPLITUDE OF 6mm MINIMUM. GENE RYAN A. ALTEA CHIEF, PLANNING AND DESIGN DIVISION SUBMITTED: AGREED WITH THE ENGINEER. COVERING MEASURED FROM THE SURFACE OF THE CONCRETE TO MELQUIADES H. STO. DOMINGO ASSISTANT REGIONAL DIRECTOR RECOMMENDED: APPROVED: GERALD A. PACANAN, CESO III REGIONAL DIRECTOR SET NO. SHEET NO.

OFFICE OF THE REGIONAL DIRECTOR EDSA DILIMAN, QUEZON CITY

PUERTO PRINCESA CITY, PALAWAN

GENERAL NOTES (3/3)

PREPARED:

GLENAILEN POJEÑAR

96 12

